#### **GENERAL NOTES GENERAL**: 1. EXISTING CONDITIONS ARE BASED ON SURVEY BY CROSSMAN ENGINEERING IN DECEMBER 2021 AND SIGNED APRIL 5, 2022. 2. THE VERTICAL DATUM IS THE NORTH AMERICAN VERTICAL DATUM OF 1988 (NAVD88). 3. THE HORIZONTAL DATUM IS BASED ON THE RHODE ISLAND STATE COORDINATE SYSTEM (NAD 1983). 4. ABUTTERS INFORMATION WAS TAKEN FROM THE CITY OF CRANSTON, RI TAX ASSESSORS RECORDS IN JANUARY OF 2022. 5. THE NORTHERLY POTION OF LOT 3141 IS ZONED C-4 HIGHWAY BUSINESS. THE REMAINDER OF LOT 3141 AND ALL OF LOT 3744 ARE ZONED INDUSTRIAL M-2 (SEE BOOK 2526, PAGE 265) PLAN REFERENCES: \_\_\_\_\_E \_\_\_\_ PLAT CARD 501 MAP 306 PLAT CARD 501 MAP 338 PLAT CARD 565 MAP 567 PLAT CARD 565 MAP 687 EXISTING SITE FEATURES SHOWN ON THESE PLANS WERE COMPILED FROM FIELD SURVEYS AND RECORD DRAWINGS. THESE PLANS DO NOT NECESSARILY DEPICT THE EXACT LOCATIONS OF ALL FEATURES WHICH MAY EXIST AT THIS TIME WITHIN THE SURVEY LIMITS. THERE MAY BE EXISTING FEATURES OTHER THAN THOSE INDICATED. 8. LAND OUTSIDE THE PROPOSED LIMIT OF WORK SHALL NOT BE DISTURBED BY THE CONTRACTOR. \_\_\_\_\_\_ 9. ALL WORK SHALL COMPLY WITH ALL O.S.H.A. STANDARDS. 10. THE CONTRACTOR SHALL BE RESPONSIBLE FOR ESTABLISHING AND MAINTAINING ALL BENCH MARKS NECESSARY FOR THE WORK. 11. THE CONTRACTOR IS RESPONSIBLE FOR OBTAINING AND PAYING FOR ANY PERMITS AND/OR CONNECTION FEES REQUIRED TO CARRY OUT THE WORK INCLUDING BUT NOT LIMITED TO DEMOLITION. 12. CONTRACTOR SHALL BE RESPONSIBLE FOR ALL RELOCATIONS THAT CONFLICT WITH THE PROPOSED IMPROVEMENTS SHOWN ON THE DRAWINGS, INCLUDING BUT NOT LIMITED TO, ALL UTILITIES, STORM DRAINAGE, SIGNS, ETC. AS REQUIRED. ALL WORK SHALL BE IN ACCORDANCE WITH GOVERNING AUTHORITY'S SPECIFICATIONS AND SHALL BE XX.XXAPPROVED BY SUCH. ALL COSTS SHALL BE BORNE BY THE CONTRACTOR. **UTILITY NOTES:** 1. THE LOCATIONS AND ELEVATIONS OF ALL EXISTING UTILITIES SHALL BE CONSIDERED APPROXIMATE AND MUST BE VERIFIED BY THE CONTRACTOR PRIOR TO ANY UTILITY CONNECTIONS OR CROSSINGS OF PROPOSED OR EXISTING UTILITIES. THE CONTRACTOR SHALL REPORT ANY DISCREPANCIES TO THE ENGINEER. THE CONTRACTOR SHALL CONTACT THE RESPECTIVE UTILITY COMPANIES RELATIVE TO THE LOCATIONS AND ELEVATIONS OF THESE LINES. NO SEPARATE OR ADDITIONAL COMPENSATION WILL BE ALLOWED TO THE CONTRACTOR DUE TO ANY VARIANCE BETWEEN THE DATA SHOWN ON THE PLANS AND ACTUAL FIELD CONDITIONS ENCOUNTERED. THE CONTRACTOR IS RESPONSIBLE FOR HIS/HER OWN DETERMINATION AS TO THE TYPE AND LOCATION OF THE EXISTING UTILITIES AS MAY BE NECESSARY TO AVOID THEIR DAMAGE AND TO FACILITATE THE PROPOSED CONNECTION(S). BEFORE STARTING CONSTRUCTION, THE CONTRACTOR SHALL BE SOLELY RESPONSIBLE FOR MAKING ALL NECESSARY ARRANGEMENTS AND FOR PERFORMING ANY NECESSARY WORK INVOLVED WITH THE UTILITY COMPANIES, WHICH WILL BE EFFECTED BY THE WORK. 3. UNLESS OTHERWISE NOTED OR APPROVED BY THE ENGINEER, THE CONTRACTOR SHALL MAINTAIN ALL EXISTING UTILITIES. 4. UTILITY PIPING INSTALLED ON A CURVED HORIZONTAL ALIGNMENT SHOULD HAVE JOINT DEFLECTIONS IN ACCORDANCE WITH THE MANUFACTURER'S RECOMMENDATIONS. UP #3 5. ALL ELEVATIONS SHOWN ARE IN REFERENCE TO THE BENCHMARK AND MUST BE VERIFIED BY THE GENERAL CONTRACTOR AT GROUNDBREAK. 6. CONTRACTOR IS RESPONSIBLE FOR DIGGING TEST HOLES AND VERIFYING EXISTING UTILITIES AND STRUCTURES PRIOR TO CONSTRUCTION. CONTRACTOR SHALL VERIFY THAT BASED ON EXACT LOCATION OF EXISTING UTILITIES THERE ARE NO CONFLICTS BETWEEN THEM AND THE PROPOSED UTILITIES. CONTRACTOR SHALL VERIFY THE SIZE AND

MATERIAL OF EXISTING STRUCTURES TO ENSURE PROPER CONNECTION OF PROPOSED TO EXISTING WORK.

8. WORK WITHIN PUBLIC WAYS SHALL COMPLY WITH APPLICABLE MUNICIPAL AND STATE REQUIREMENTS.

EXISTING STRUCTURE AS NECESSARY TO RETURN IT TO EXISTING CONDITIONS OR BETTER.

12. IMPORTED SOILS MUST MEET RIDEM RDEC AND GB LEACHABILITY CRITERIA OR BE CERTIFIED AS NON-JURISDICTIONAL.

3. SEDIMENTATION AND EROSION CONTROL MEASURES TO BE ADJUSTED AS NEEDED WITHIN ACTIVE LIMIT OF DISTURBANCE.

ANY NECESSARY REPLACEMENT OR REPAIR SHALL BE PERFORMED PROMPTLY BY THE CONTRACTOR.

10. LEGALLY DISPOSE OF EXISTING DEBRIS PER LAWS AND REGULATIONS.

COVERED LOCATIONS OR TAKEN OFF-SITE AT THE END OF EACH DAY.

SEDIMENTATION & EROSION CONTROL NOTES:

EROSION CONTROL MEASURES OUTSIDE THE PERMANENT SEEDING TIME FRAME.

8. CONTRACTOR SHALL COORDINATE LOCATION OF CONSTRUCTION ENTRANCE WITH OWNER.

WASTEWATER IN ACCORDANCE WITH LOCAL REGULATIONS.

PRIOR TO ANY CONSTRUCTION ACTIVITIES.

DIRECTED BY THE ENGINEER.

8. CONTRACTOR SHALL NOTIFY THE UTILITY AUTHORITY'S INSPECTORS 72 HOURS BEFORE CONNECTING TO ANY EXISTING LINE.

WRITING BY THE ENGINEER.

**CONSTRUCTION NOTES:** 

RESULT OF THE CONTRACTOR'S WORK.

REGULATIONS.

ALL DRAINAGE STRUCTURES SHALL HAVE THEIR RIMS SET TO FINISHED GRADE REGARDLESS OF ANY ELEVATIONS OTHERWISE SHOWN, UNLESS OTHERWISE DIRECTED IN

9. CONTRACTOR IS RESPONSIBLE FOR COMPLYING WITH THE SPECIFICATIONS OF THE LOCAL AUTHORITIES WITH REGARDS TO MATERIALS AND INSTALLATION OF UTILITIES.

1. THE CONTRACTOR SHALL CALL "DIG SAFE" AT 811 OR 1-888-344-7233 AT LEAST 72 HOURS PRIOR TO EXCAVATION IN ACCORDANCE WITH STATE OF RHODE ISLAND,

3. THE CONTRACTOR SHALL COMPLY WITH ALL APPLICABLE FEDERAL, STATE AND LOCAL SAFETY CODES, REGULATIONS, LEGAL REQUIREMENTS, PERMIT CONDITIONS, ETC.

5. THE CONTRACTOR SHALL PROVIDE ADEQUATE BRACING AND SHORING OF ALL EXCAVATIONS IN ACCORDANCE WITH THE REQUIREMENTS OF ALL GOVERNING CODES AND

6. ALL EXISTING PIPING AND STRUCTURES EXPOSED DURING EXCAVATION SHALL BE ADEQUATELY SUPPORTED, BRACED, OR OTHERWISE PROTECTED DURING CONSTRUCTION

9. IF ANY EXISTING STRUCTURES TO REMAIN ARE DAMAGED DURING CONSTRUCTION IT SHALL BE THE CONTRACTOR'S RESPONSIBILITY TO REPAIR AND/OR REPLACE THE

7. ALL SURFACES OUTSIDE THE LIMIT OF WORK THAT ARE DISTURBED SHALL BE RESTORED TO THEIR ORIGINAL CONDITION, AS DETAILED, OR AS SPECIFIED BY THE ENGINEER.

11. MATERIALS THAT MAY BE A SOURCE OF STORMWATER POLLUTION SUCH AS GASOLINE, DIESEL FUEL, HYDRAULIC OIL, ETC. SHOULD BE STORED IN A STORAGE TRAILER OR

1. SOIL AND EROSION CONTROLS SHALL BE PLACED PRIOR TO ANY CONSTRUCTION ACTIVITIES. CONTRACTOR TO NOTIFY THE ENGINEER AND THE OWNER AT LEAST 48 HOURS

2. THE CONTRACTOR SHALL BE RESPONSIBLE FOR IMPLEMENTING ALL EROSION CONTROL MEASURES NECESSARY TO PREVENT OFF-SITE TRACKING OF EARTH, SEDIMENT AND

4. PERMANENT SEEDING SHALL OCCUR BETWEEN MARCH 1 AND JUNE 15, OR BETWEEN AUGUST 15 AND OCTOBER 15. INSTALL EROSION CONTROL BLANKETS OR SIMILAR

6. EROSION CONTROL MEASURES SHALL BE INSPECTED AT A MINIMUM FREQUENCY OF ONCE EVERY WEEK, AND DURING AND AFTER EVERY RAIN EVENT GREATER THAN 0.25".

7. DUST SHALL BE CONTROLLED AS NECESSARY THROUGH THE USE OF WATER. THE USE OF CALCIUM CHLORIDE FOR DUST CONTROL IS NOT ALLOWED, UNLESS OTHERWISE

9. CONTRACTOR SHALL COORDINATE LOCATION OF CONCRETE WASHOUT WITH OWNER. THE CONTRACTOR IS RESPONSIBLE FOR PROPERLY MANAGING CONCRETE WASHOUT

5. ALL SITE SOILS TO BE STOCKPILED FOR MORE THAN 14 DAYS SHALL BE SURROUNDED BY EROSION CONTROL BARRIERS AND TEMPORARILY SEEDED AND MULCHED.

THE CONTRACTOR SHALL NOTIFY ALL APPROPRIATE AGENCIES AND UTILITY COMPANIES IN WRITING 48 HOURS PRIOR TO ANY CONSTRUCTION WITHIN 15 FEET OF A UTILITY

4. THE CONTRACTOR SHALL TAKE ADEQUATE PRECAUTIONS TO PROTECT ALL WALKS, STREETS, PAVEMENTS, HIGHWAY GUARDS, CURBING, EDGING, TREES AND PLANTINGS ON OR

OFF THE PREMISES, AND SHALL REPAIR AND REPLACE OR OTHERWISE MAKE GOOD AT HIS/HER OWN EXPENSE AS DIRECTED BY THE ENGINEER ANY ITEMS DAMAGED AS A

## AS-BUILT CONTOUR (1' INTERVAL) CONTOUR (INDEX) WATER MAIN STORM DRAIN PIPE TELEPHONE DUCT BANK GAS LINE SANITARY SEWER OVERHEAD WIRES ELECTRIC DUCT BANK FIRE PROTECTION FENCE GUARD RAIL RETAINING WALL PROPERTY LINE CURB EDGE OF PAVEMENT LIMIT OF WORK SILTSOCK SPOT ELEVATION WATER MANOLE WATER GATE VALVE WATER METER HYDRANT CATCH BASIN SILTSACK DRAIN MANHOLE / OUTLET CONTROL STRUCTURE SEWER MANHOLE CLEANOUT UNKNOWN MANHOLE LIGHT POLE UTILITY POLE ELECTRICAL VEHICLE CHARGE ELECTRICAL HANDHOLE GAS METER BOX GAS GATE VALVE UTILITY CAP SIGN FLAGPOLE BOLLARD WHEEL STOP TEST PIT & NUMBER BORING & NUMBER LIMIT OF TRENCH DEMOLITION CONCRETE BITUMINOUS PAVEMENT ACCESSIBLE SYMBOL ACCESSIBLE CURB RAMP STABILIZED CONSTRUCTION ENTRANCE

FIN GR

FLR'G

HORIZONTAL

HIGH POINT HIGH PRESSURE


<u>LEGEND</u>

ANCHOR BOLTS INSIDE DIAMETER ABANDONED ACRES; ASBESTOS CEMENT INSULATED AGGREGATE INSULATION INTERIOR INVERT ALTERNATE ALUMINUM AMERICAN NATIONAL STANDARDS INSTITUTE ASSESSORS PLAT JELLYFISH FILTER AMERICAN PLYWOOD ASSOCIATION JUNCTION APPROXIMATE AVERAGE KILN DRIED BITUMINOUS CONCRETE CURB LANDSCAPE AREA BITUMINOUS CONCRETE LOW POINT LOW PRESSURE BOTTOM OF FOOTING BOTTOM OF SILL MAXIMUM MOISTURE CONTENT BOTTOM OF WALL MECHANICAL MANUFACTURER METAL GUARDRAIL CATCH BASIN MANHOLE METAL HANDRAIL CONCRETE CURB CHILLED WATER MECHANICAL JOINT CHILLED WATER RETURN CHILLED WATER SUPPLY CAST IRON / CURB INLETS NOW OR FORMERLY CLEARING LIMITS NATIONAL GRID CHAIN LINK FENCE NOT IN CONTRACT CHI ORINATION NOT TO SCALE CORRUGATED METAL PIPE CONCRETE MASONRY UNIT ON CENTER OUTSIDE DIAMETER CONCRETE SIDEWALK OVERHANG OPERATOR OVERHEAD WIRES PLANTED AREA CONSTRUCTION PROJECT BENCHMARK POST INDICATOR VALVE CONCRETE PAD PLYWOOD CONCRETE RETAINING WALL CARBON STEEL, CURB STOP, CRUSHED STONE POSSIBLE POUNDS PER SQUARE FOOT CITY WATER POUNDS PER SQUARE INCH PRESSURE TREATED DEED BOOK, PAGE DIRECT BURIAL CABLE POLYVINYL CHLORIDE DOUBLE CATCH BASIN RADIUS; RECORD REINFORCED CONCRETE ELLIPTICAL PIPE DRAIN MANHOLE REINFORCED CONCRETE PIPE ROOF DRAIN DOMESTIC WATER ROOF DRAIN/UNDERGROUND ELECTRICAL REINFORCED REQUIRED EACH FACE RESILIENT ELECTRIC HANDHOLE RETAINING WALL RIGHT OF WAY ELECTRICAL CONDUIT ELECTRIC METER STORM DRAIN ELECTRICAL MANHOLE STANDARD DIMENSION RATION EDGE OF PAVEMENT ELECTRIC PAINT MARK FOUIPMENT SEASONAL HIGH GROUNDWATER TABLE EACH WAY SILL ELEVATION **EXPANSION** SEWER MANHOLE SUPPORT OF EXCAVATION EXTENSION SPECIFICATIONS BENDING STRESS COMPRESSIVE STRESS STAINLESS STEEL STANDARD FIRE DEPARTMENT SPRINKLER CONTROL STRUCTURE TENSILE STRESS STORM SINGLE WHITE LINE FLOOR DRAIN SINGLE YELLOW LINE FOUNDATION SUSPENDED FIRE EXTINGUISHER FINISH FLOOR ELEVATION TEMPORARY BENCH MARK FINISH GRADE TOP OF CURB FLUSH THRESHOLD FLOORING TRAFFIC LOOP DETECTOR FORCE MAIN TOP OF PLATE TRANSFORMER TYPE UNKNOWN TOP OF WALL GALVANIZED UTILITY COVER UNDERGROUND GRANITE CURB FLUSH UNDERGROUND CONDUIT GAS GATE VALVE UTILITY POLE GALLONS PER HOUR GALLONS PER MINUTE; GAS PAINT MARK VAPOR BARRIER VERTICAL GRANITE CURB DOMESTIC WATER GYPSUM WALLBOARD WATER CLOSET HIGH-DENSITY POLYETHYLENE WATER GATE VALVE WATER RESISTANT HOT WATER RETURN WATER SERVICE HOT WATER SUPPLY WEATHER STRIPPING HOLLOW METAL WATER GATE VALVE

\*THESE ARE GENERAL ABBREVIATIONS. NOT ALL APPEAR

**ABBREVIATIONS\*** 



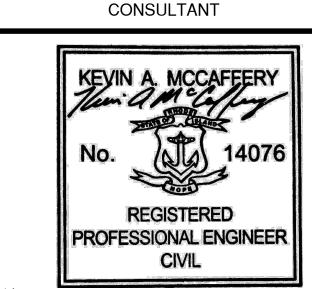

& Curran

SSUE DATE: PERMITTING SET 6/12/2024 REVISIONS: DATE DESCRIPTION

> FOR ALL ABBREVIATIONS, SYMBOLS LEGENDS, AND GENERAL NOTES SEE SHEET C-000


KEY PLAN


SCALE: AS NOTED NORTH



MANUFACTURING AND WAREHOUSING FACILITY FOR TACO COMFORT SOLUTIONS, INC. 35 CARLSBAD STREET, CRANSTON, RI 02920 PROJECT NUMBER: 2022-077 DRAWN BY: KCC **REVIEWED BY: CG** GENERAL NOTES, LEGEND, AND **ABBREVIATIONS** 

NEW INDUSTRIAL

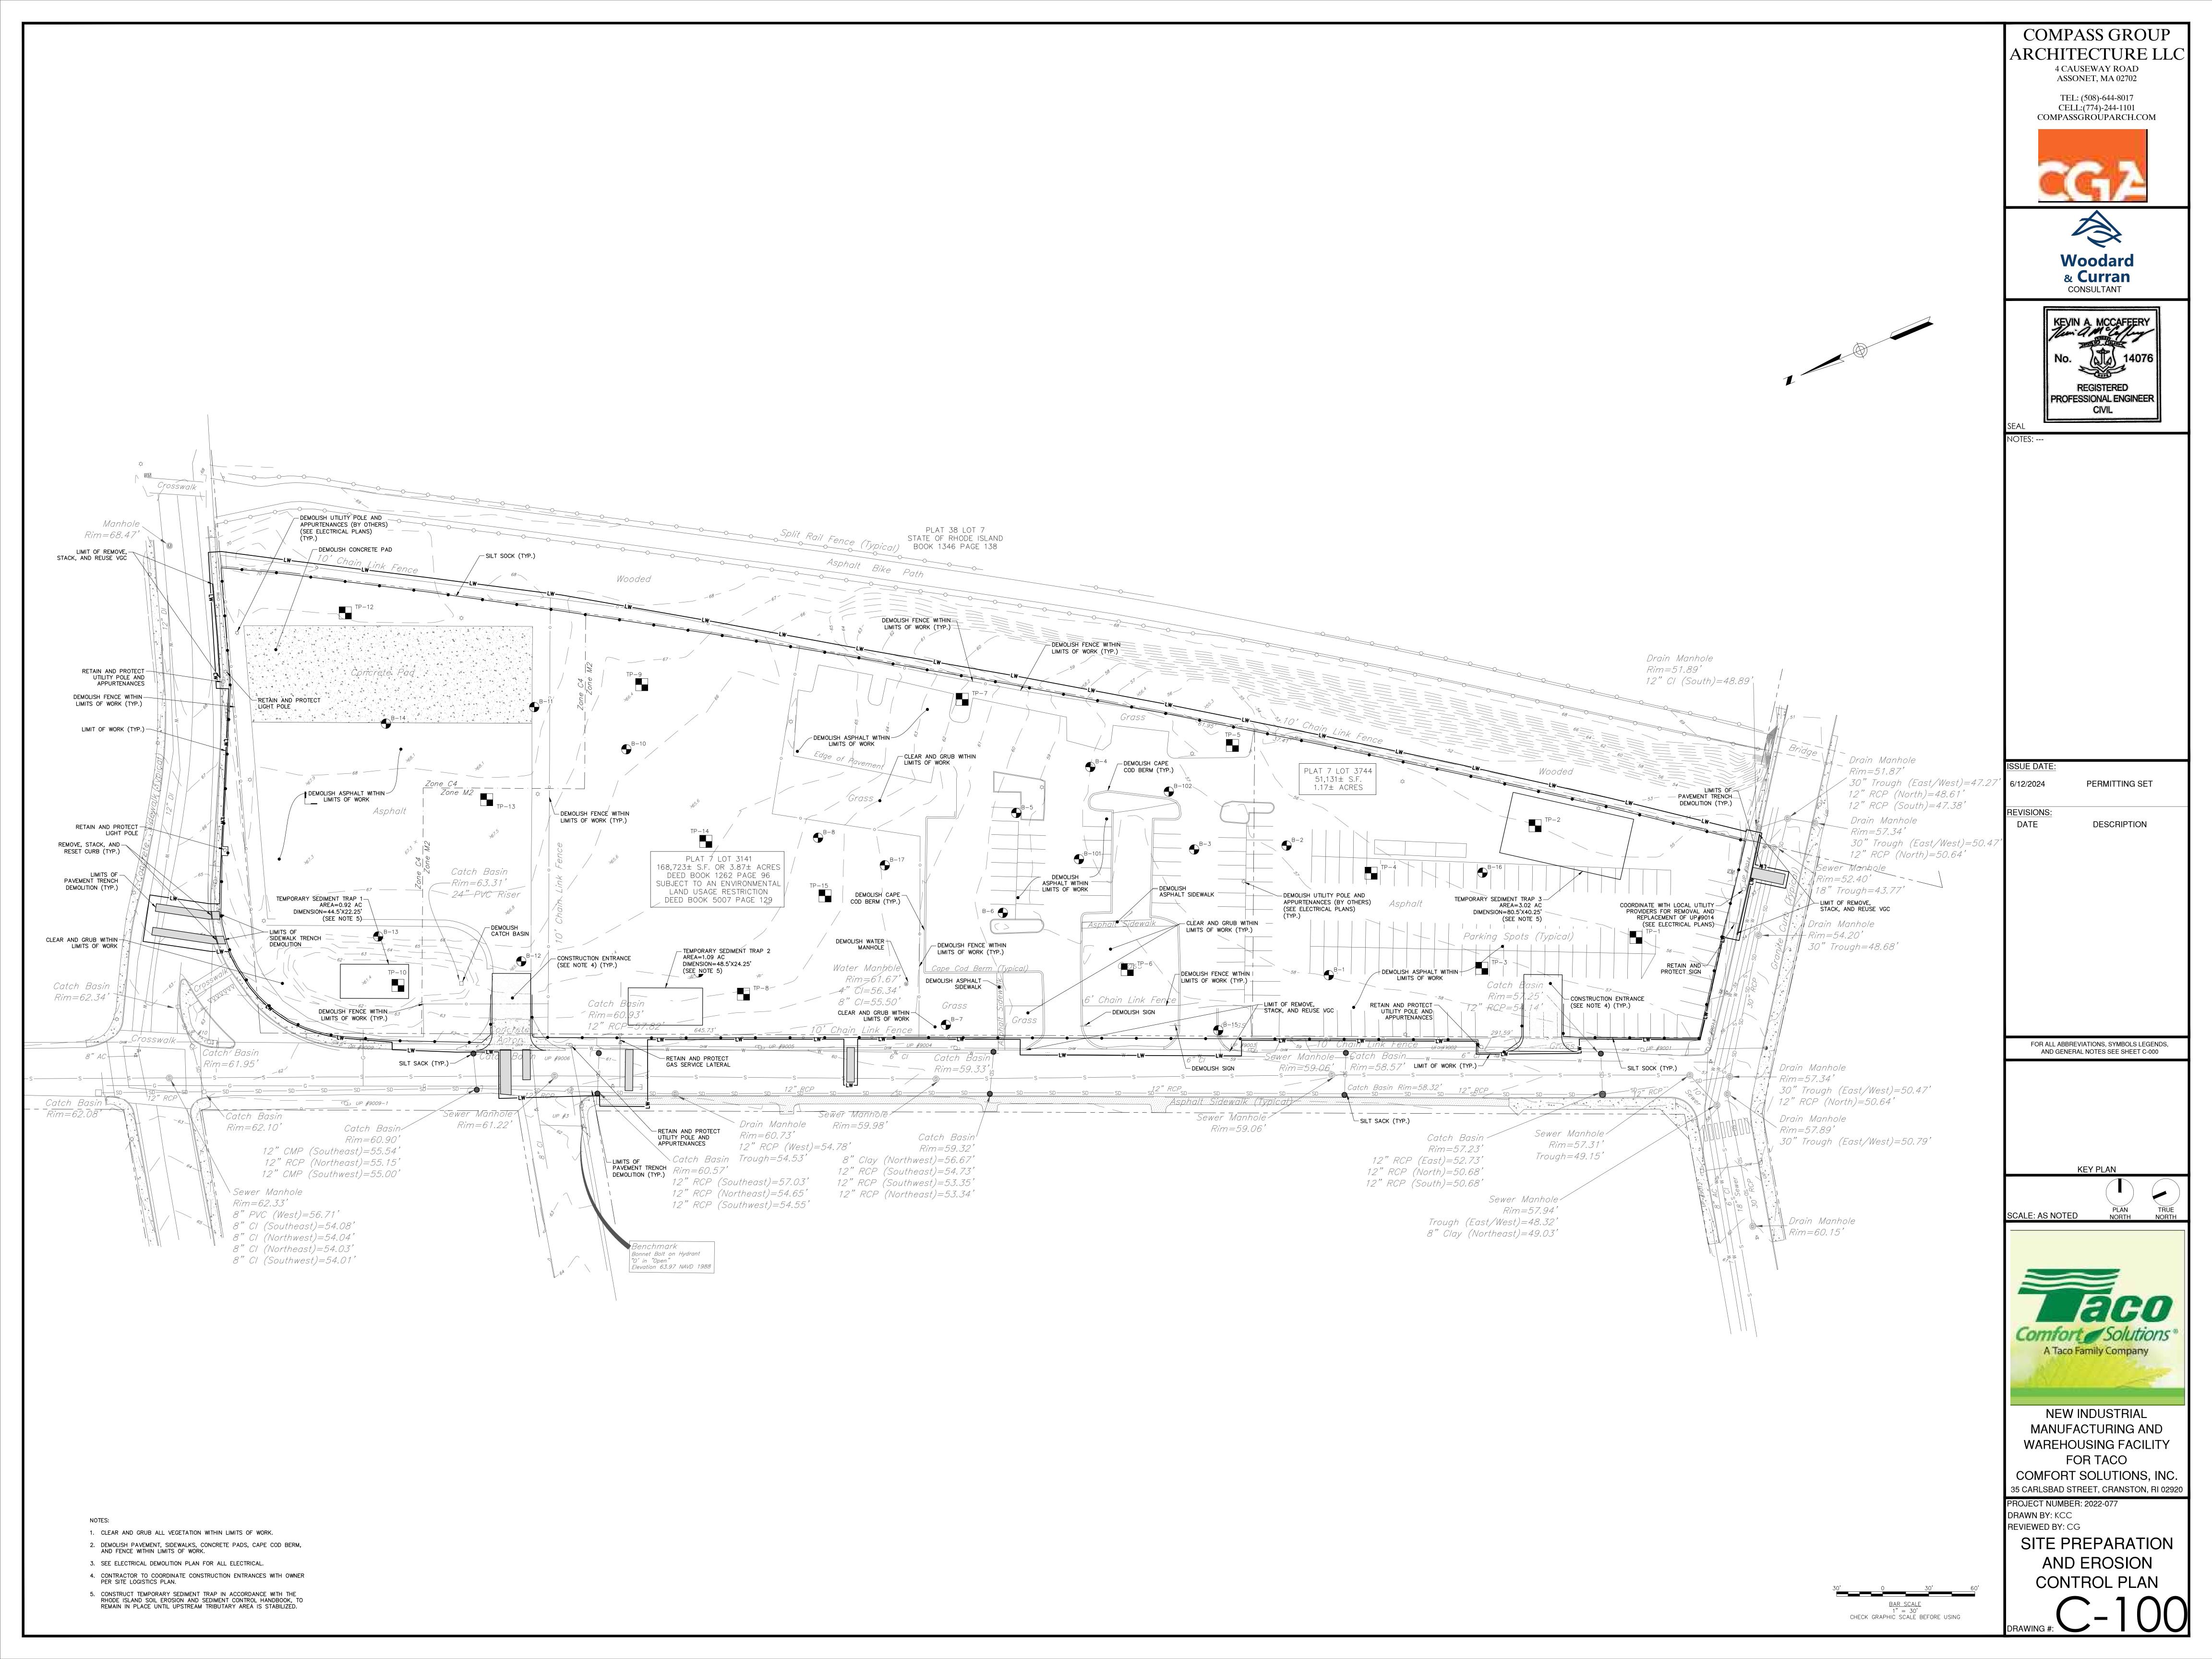

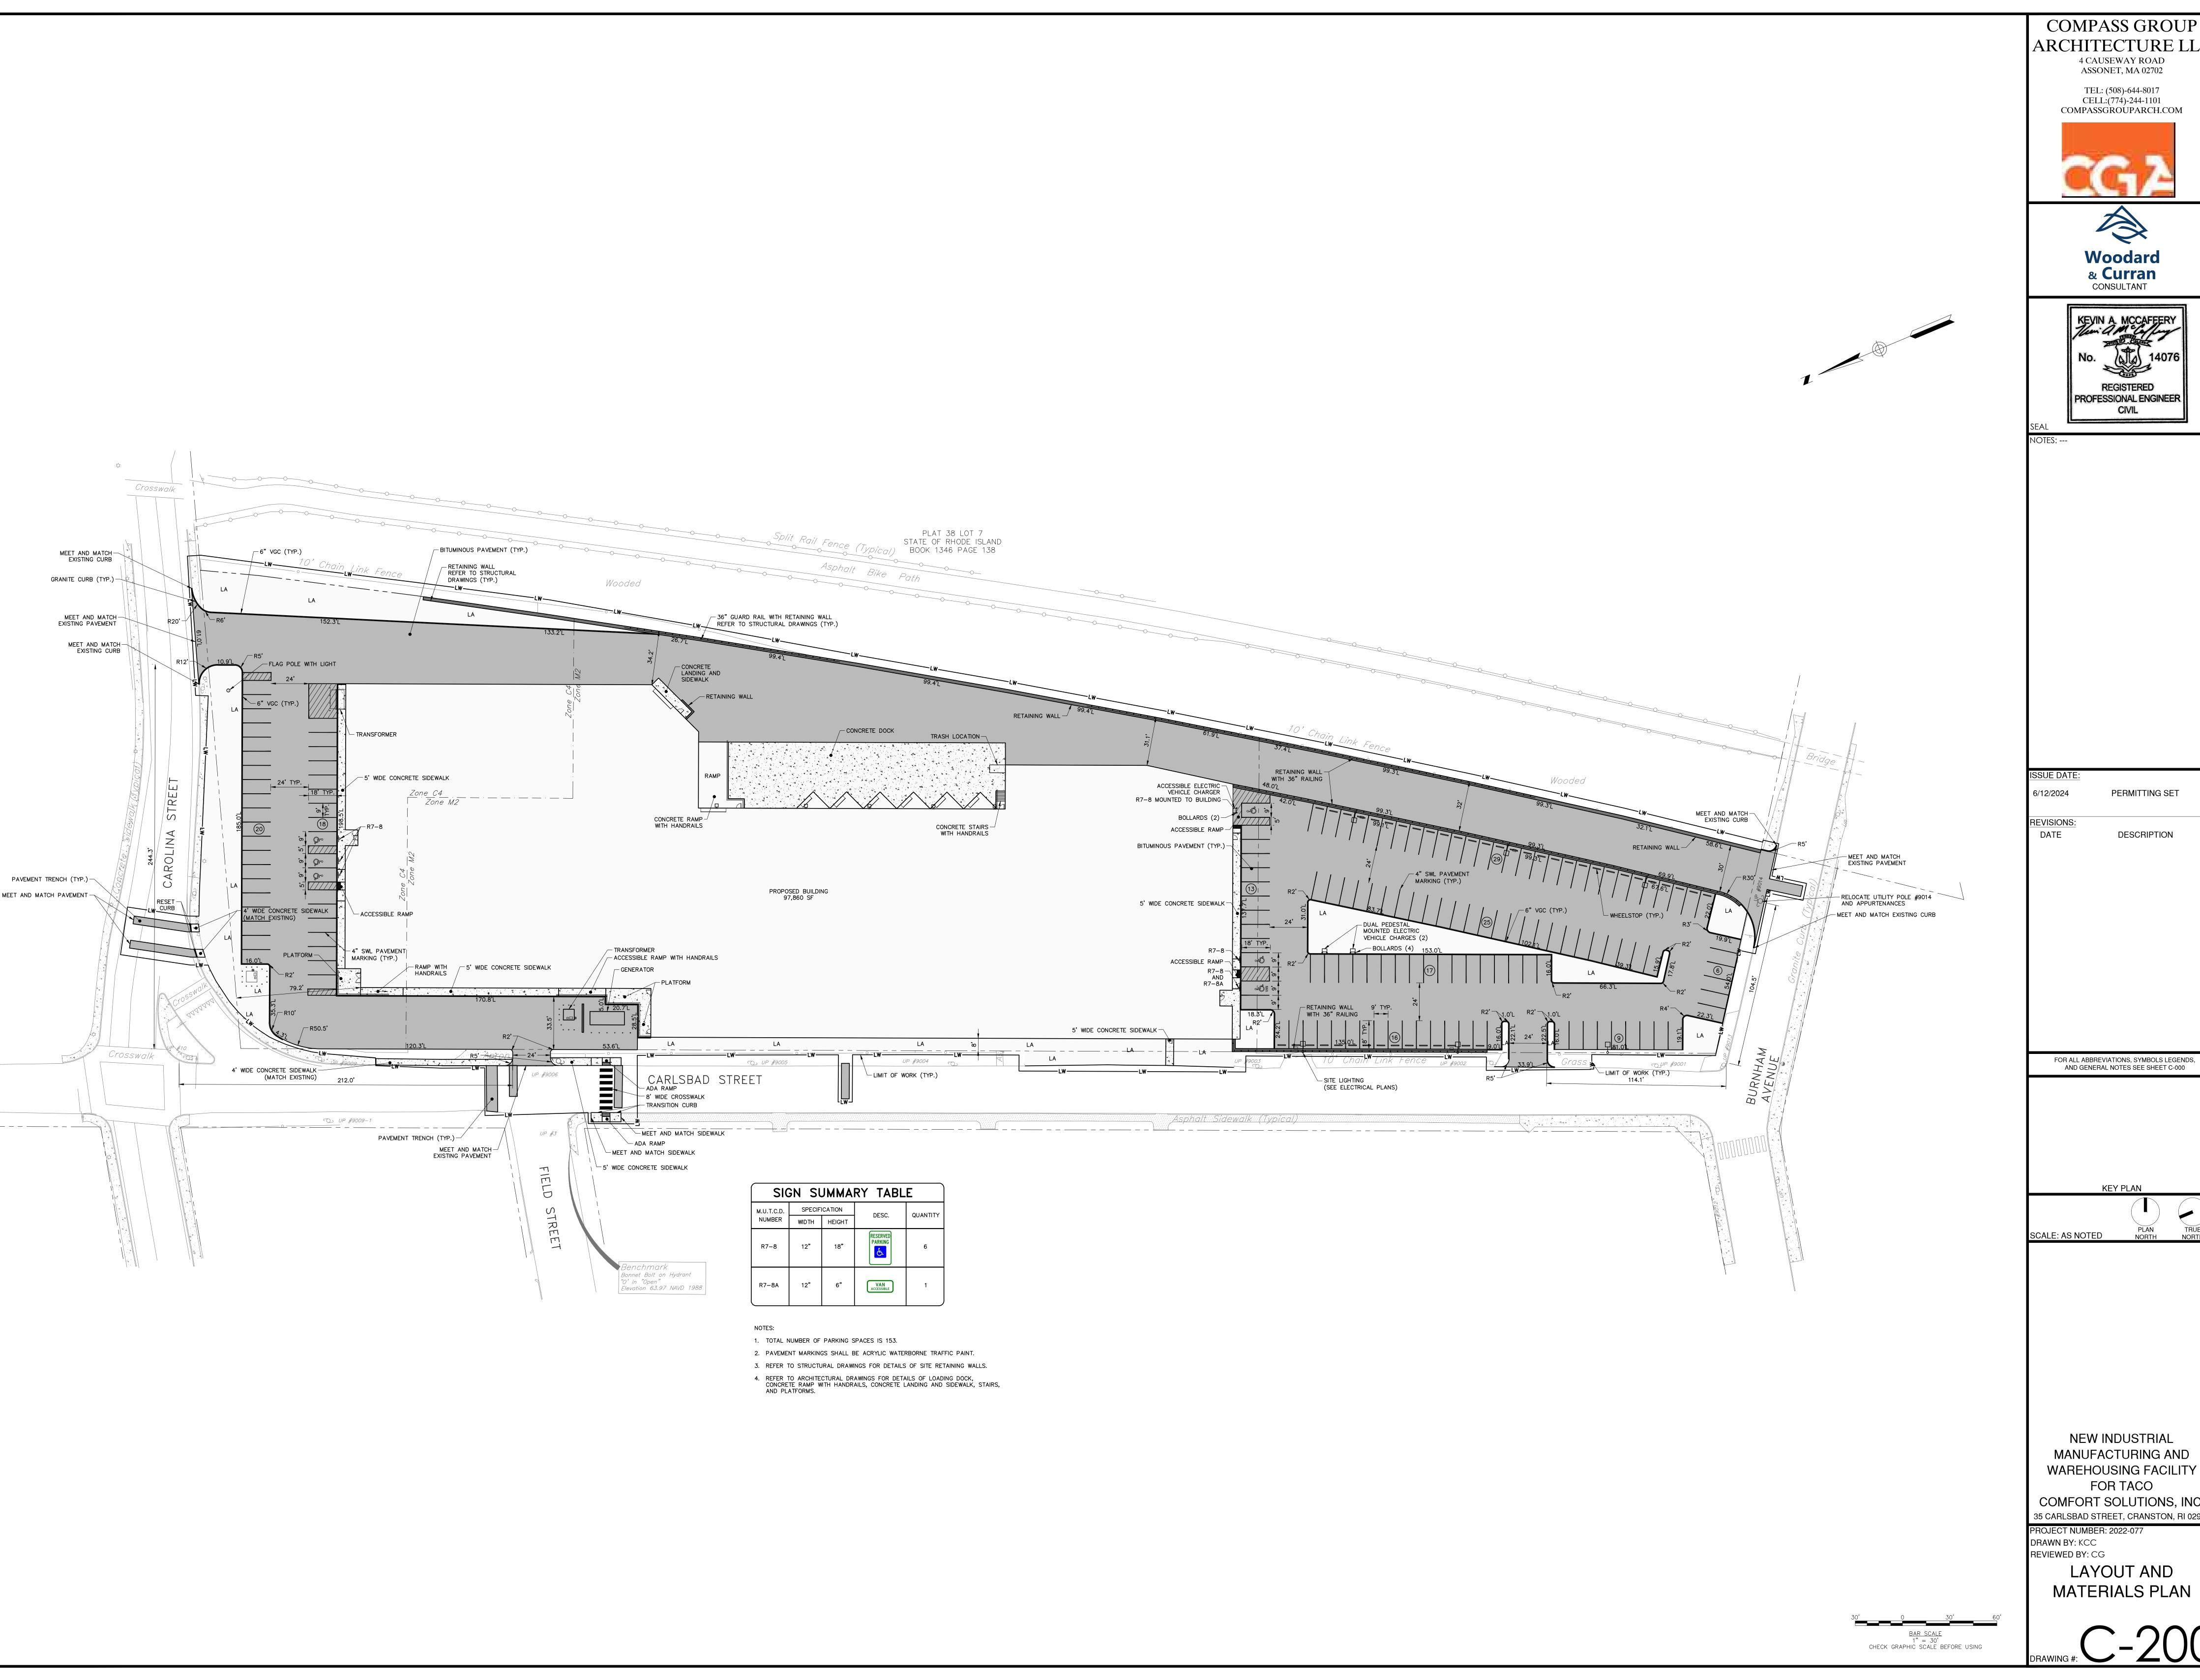

**COMPASS GROUP** ARCHITECTURE LLC 4 CAUSEWAY ROAD ASSONET, MA 02702 TEL: (508)-644-8017 CELL:(774)-244-1101 COMPASSGROUPARCH.COM





ISSUE DATE:

PERMITTING SET

DESCRIPTION

AND GENERAL NOTES SEE SHEET C-000

**KEY PLAN** 


PLAN NORTH


SCALE: AS NOTED

**NEW INDUSTRIAL** MANUFACTURING AND WAREHOUSING FACILITY FOR TACO COMFORT SOLUTIONS, INC. 35 CARLSBAD STREET, CRANSTON, RI 02920

PROJECT NUMBER: 2022-077 DRAWN BY: KCC

REVIEWED BY: CG LAYOUT AND

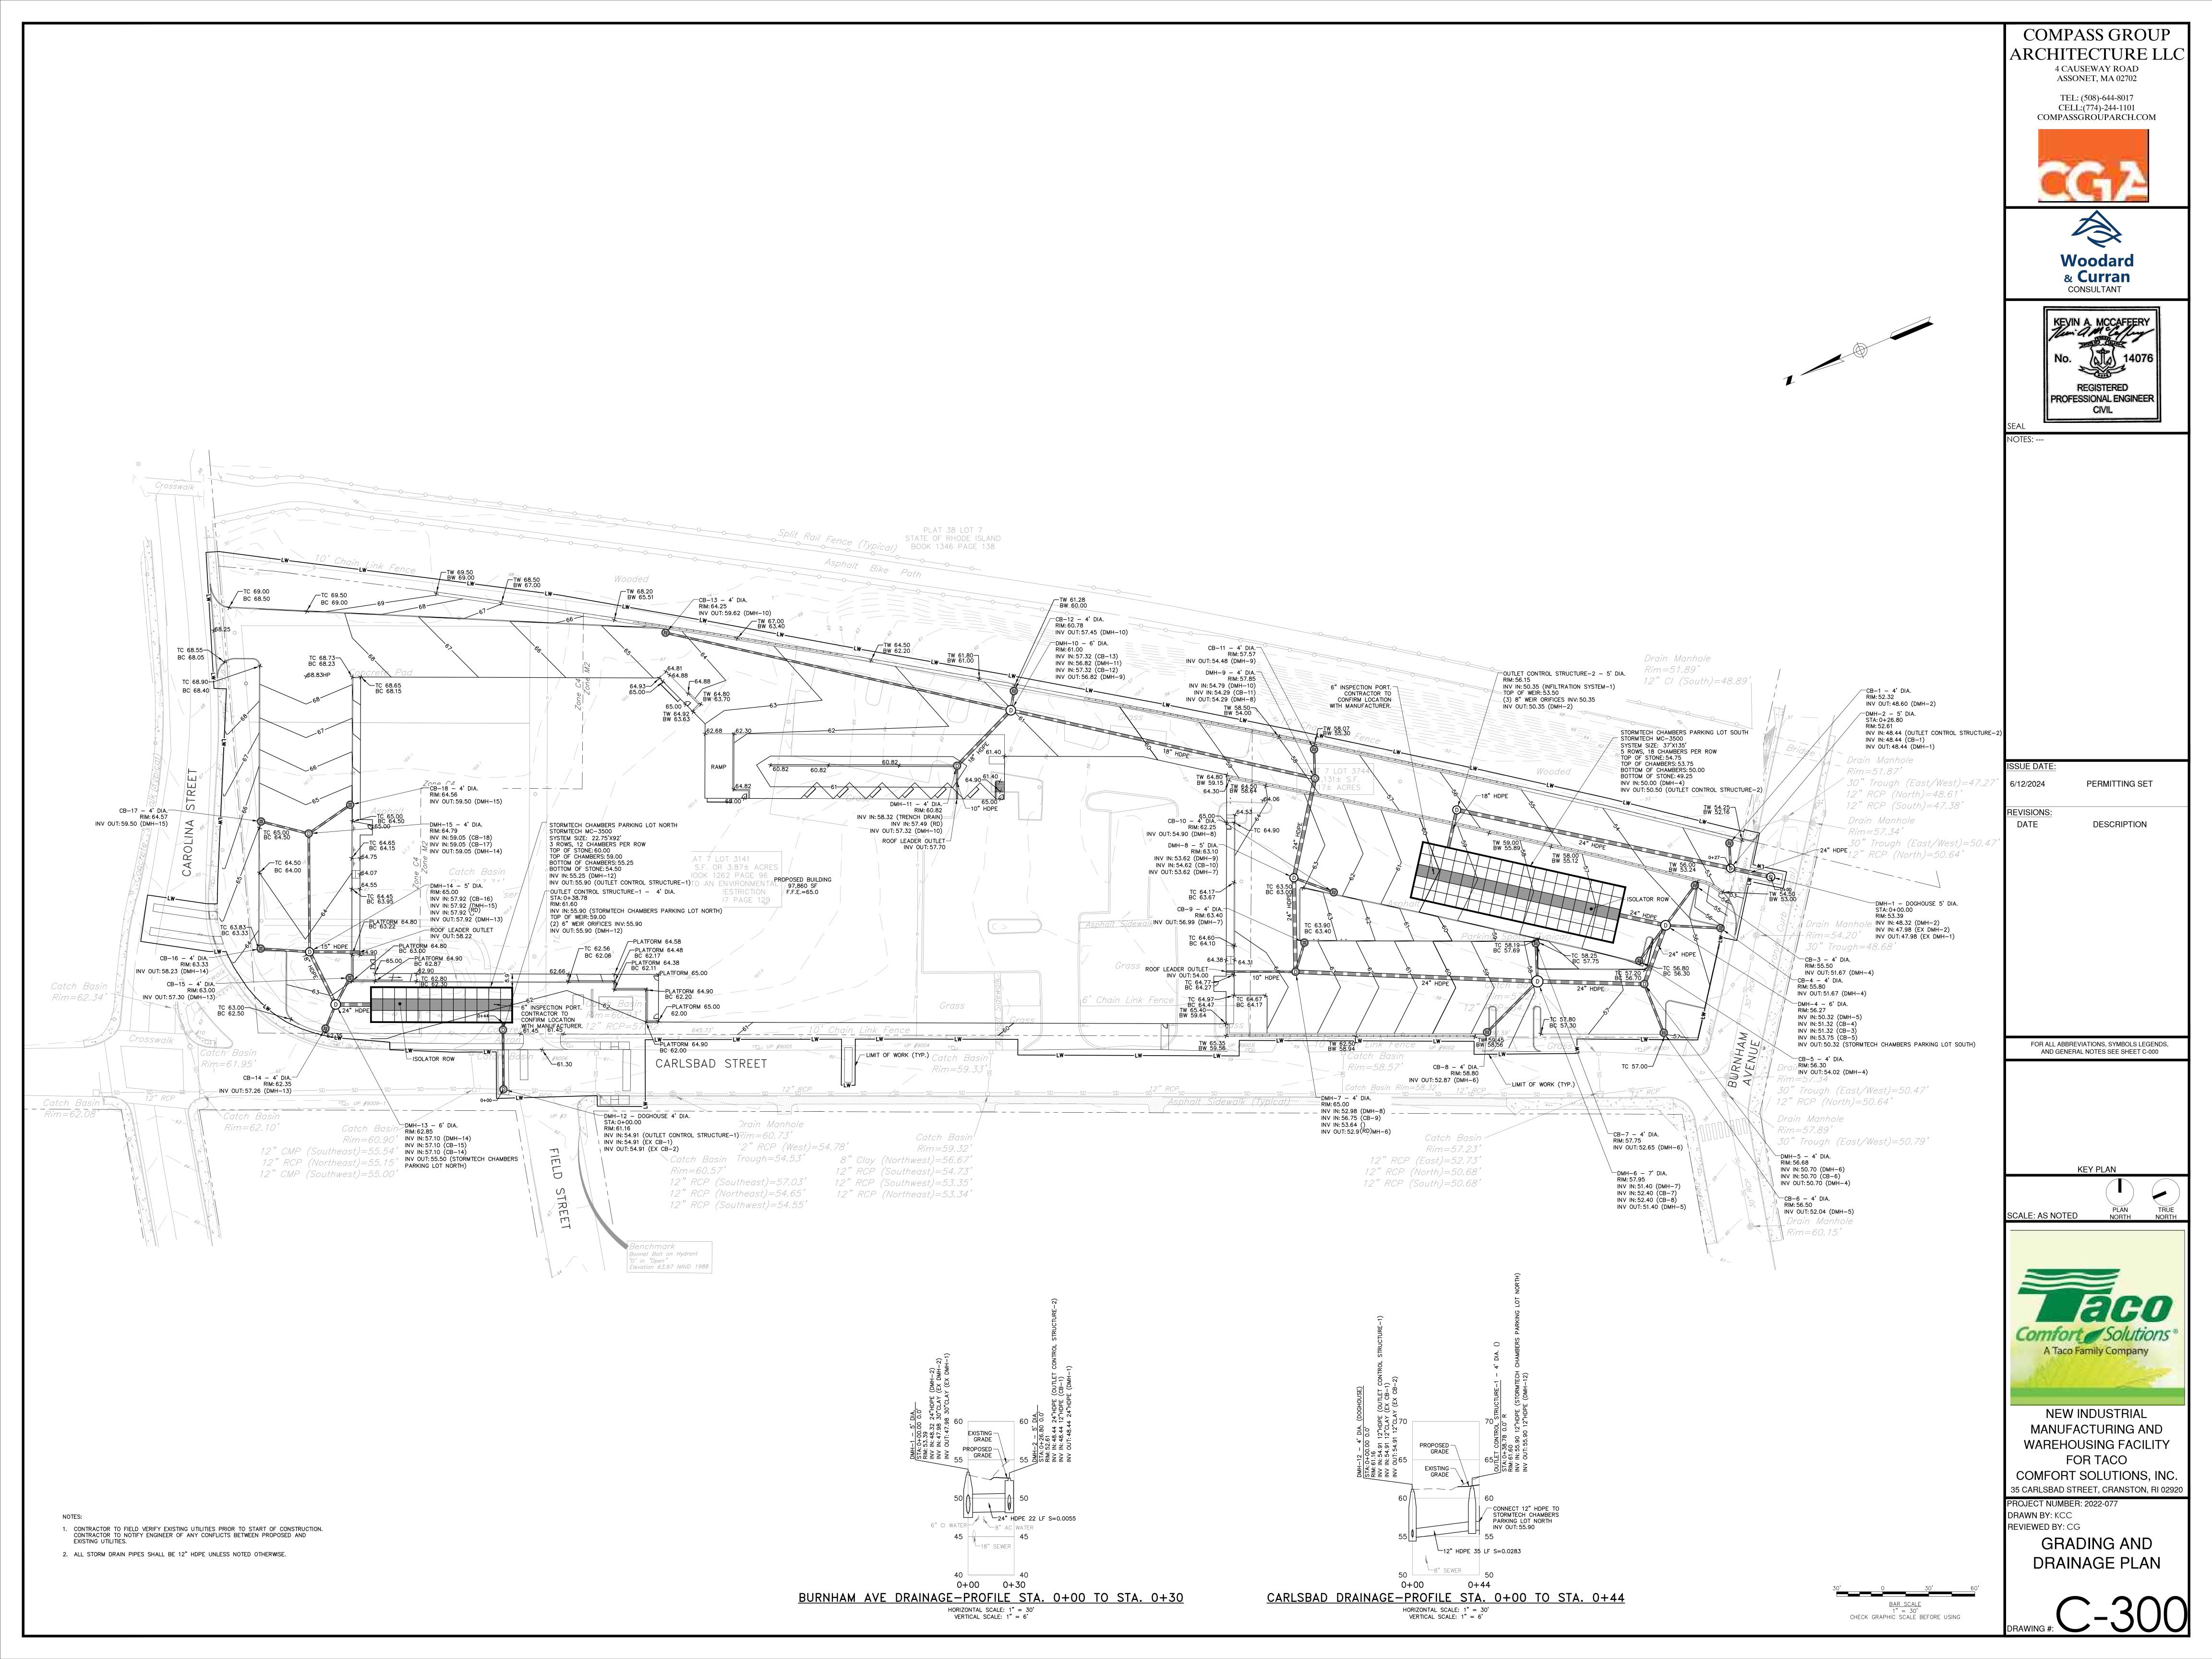


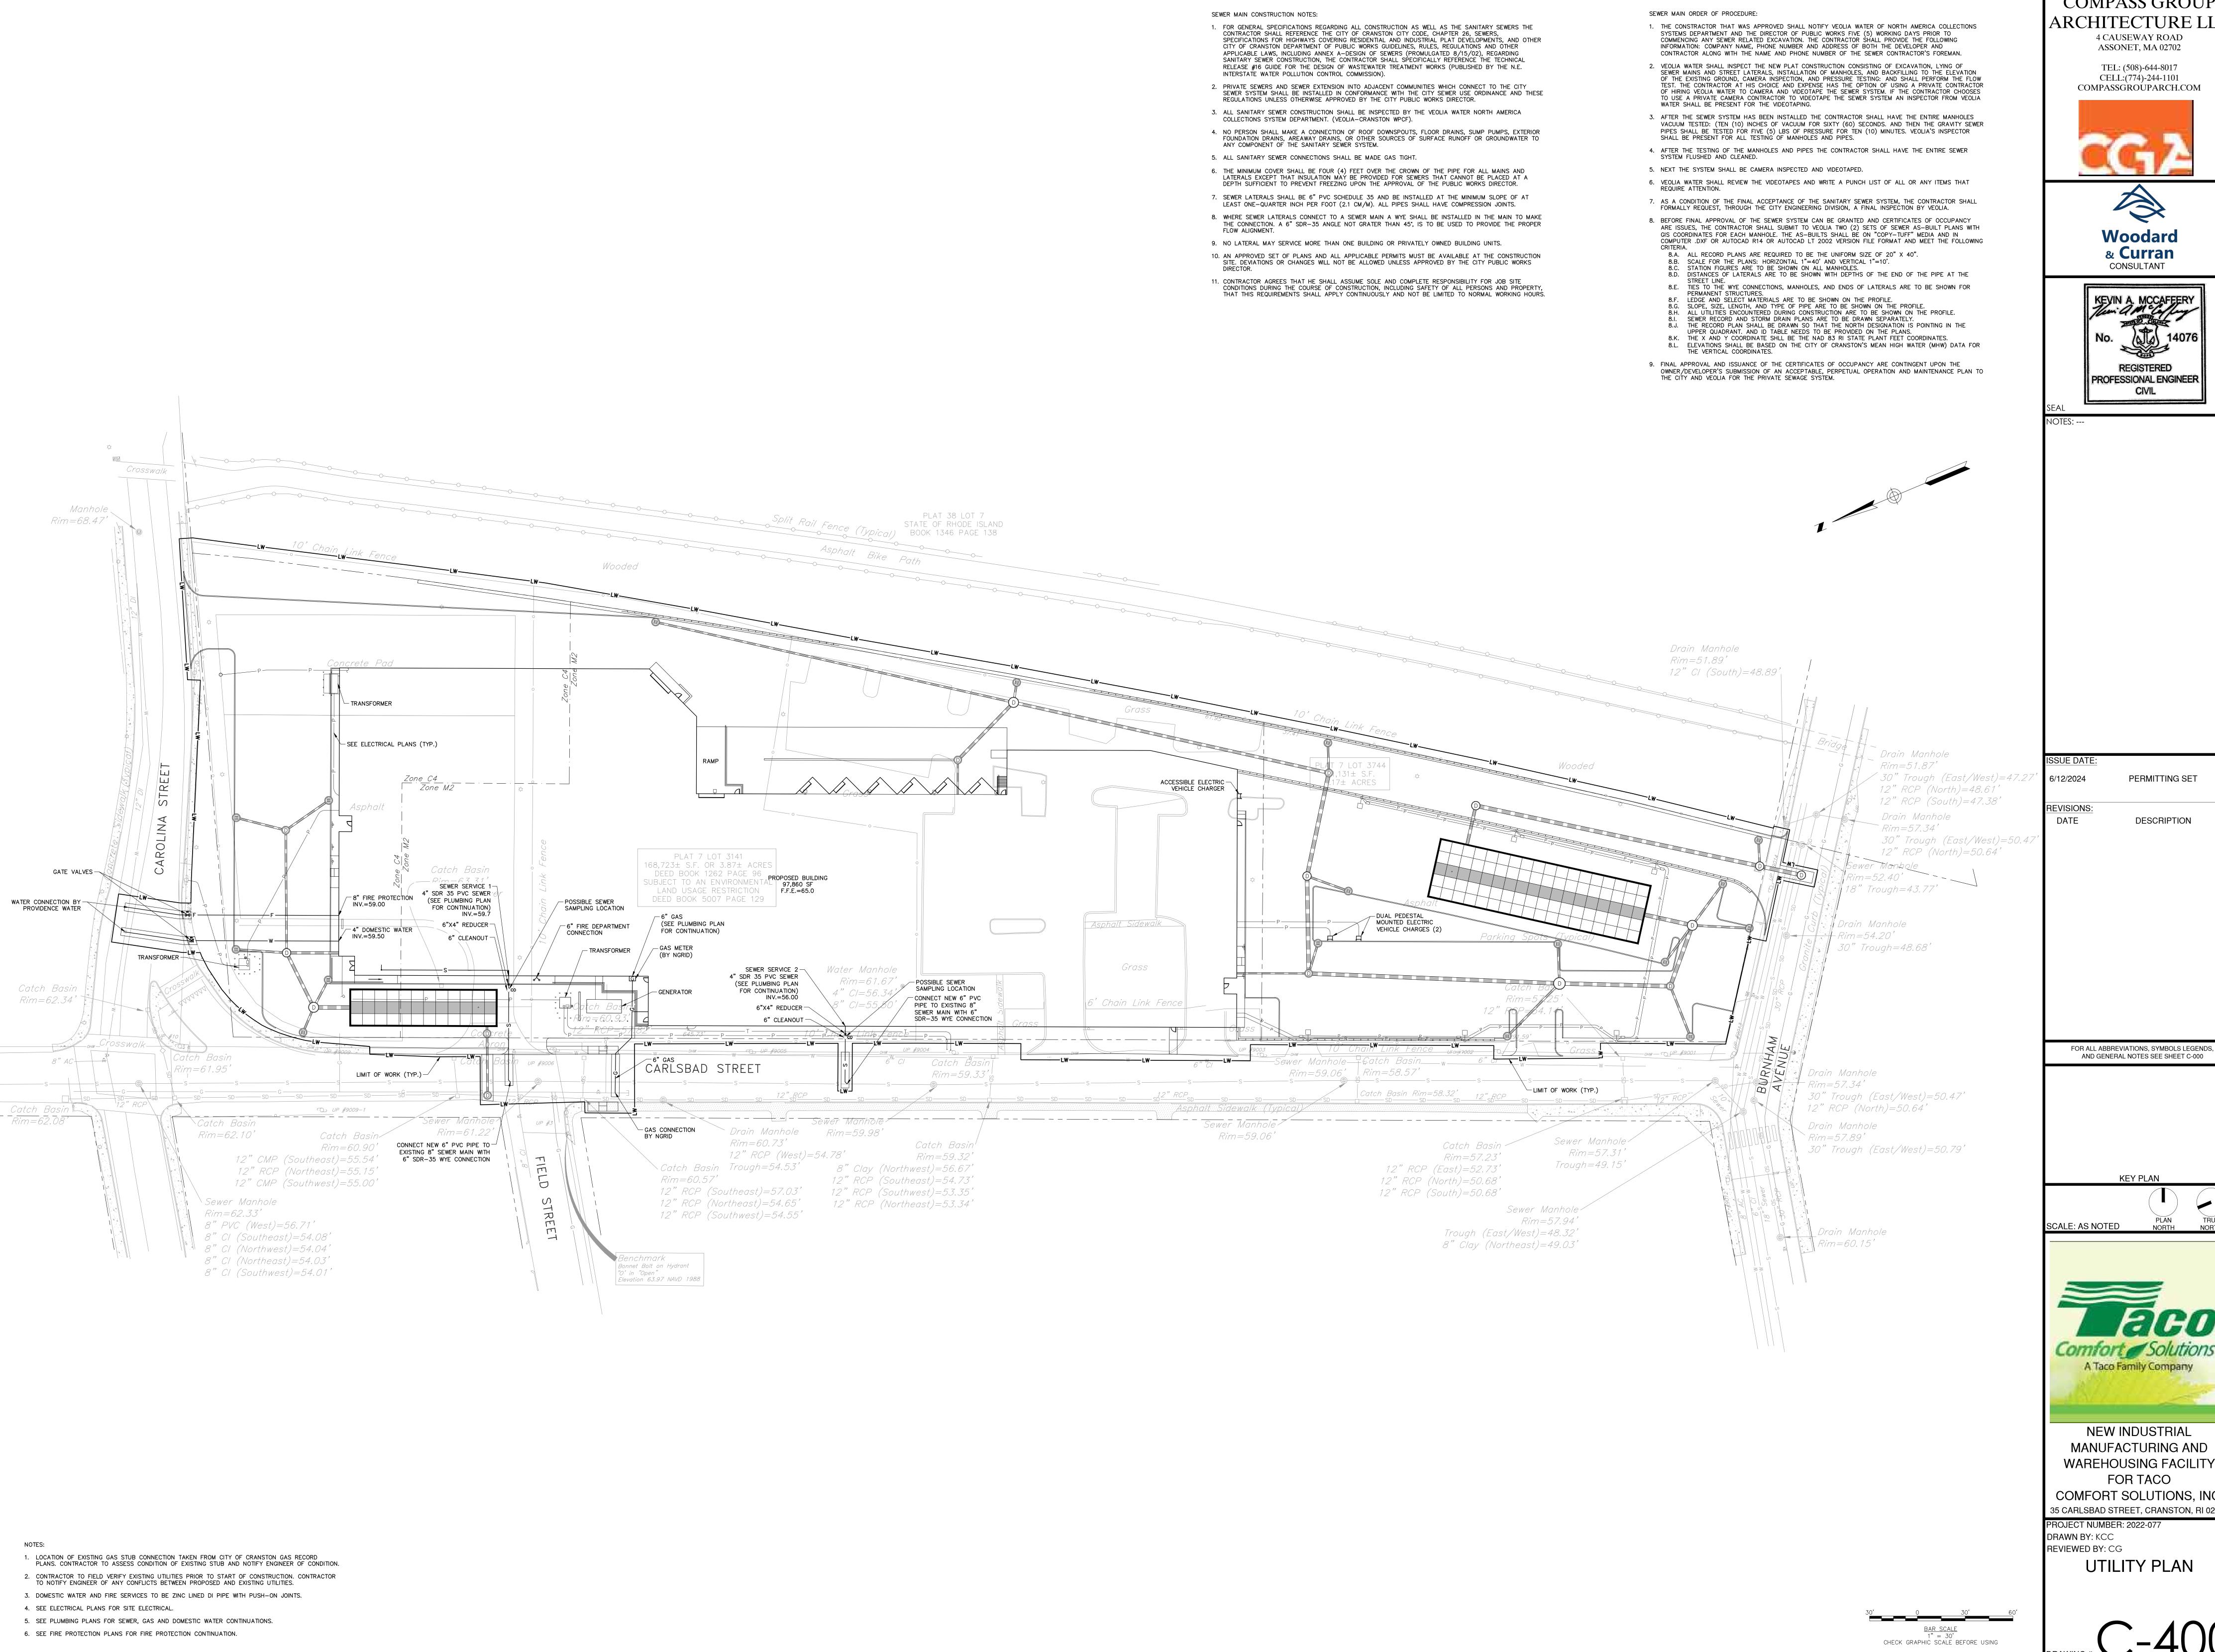


COMPASS GROUP ARCHITECTURE LLC 4 CAUSEWAY ROAD

ASSONET, MA 02702 TEL: (508)-644-8017 CELL:(774)-244-1101 COMPASSGROUPARCH.COM



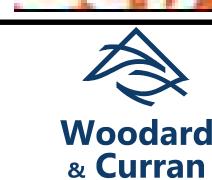

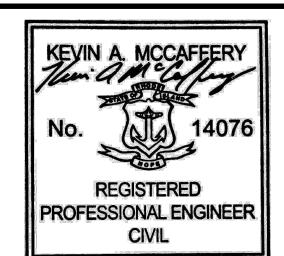

PERMITTING SET

DESCRIPTION


AND GENERAL NOTES SEE SHEET C-000

KEY PLAN

NORTH



MANUFACTURING AND WAREHOUSING FACILITY FOR TACO COMFORT SOLUTIONS, INC. 35 CARLSBAD STREET, CRANSTON, RI 02920

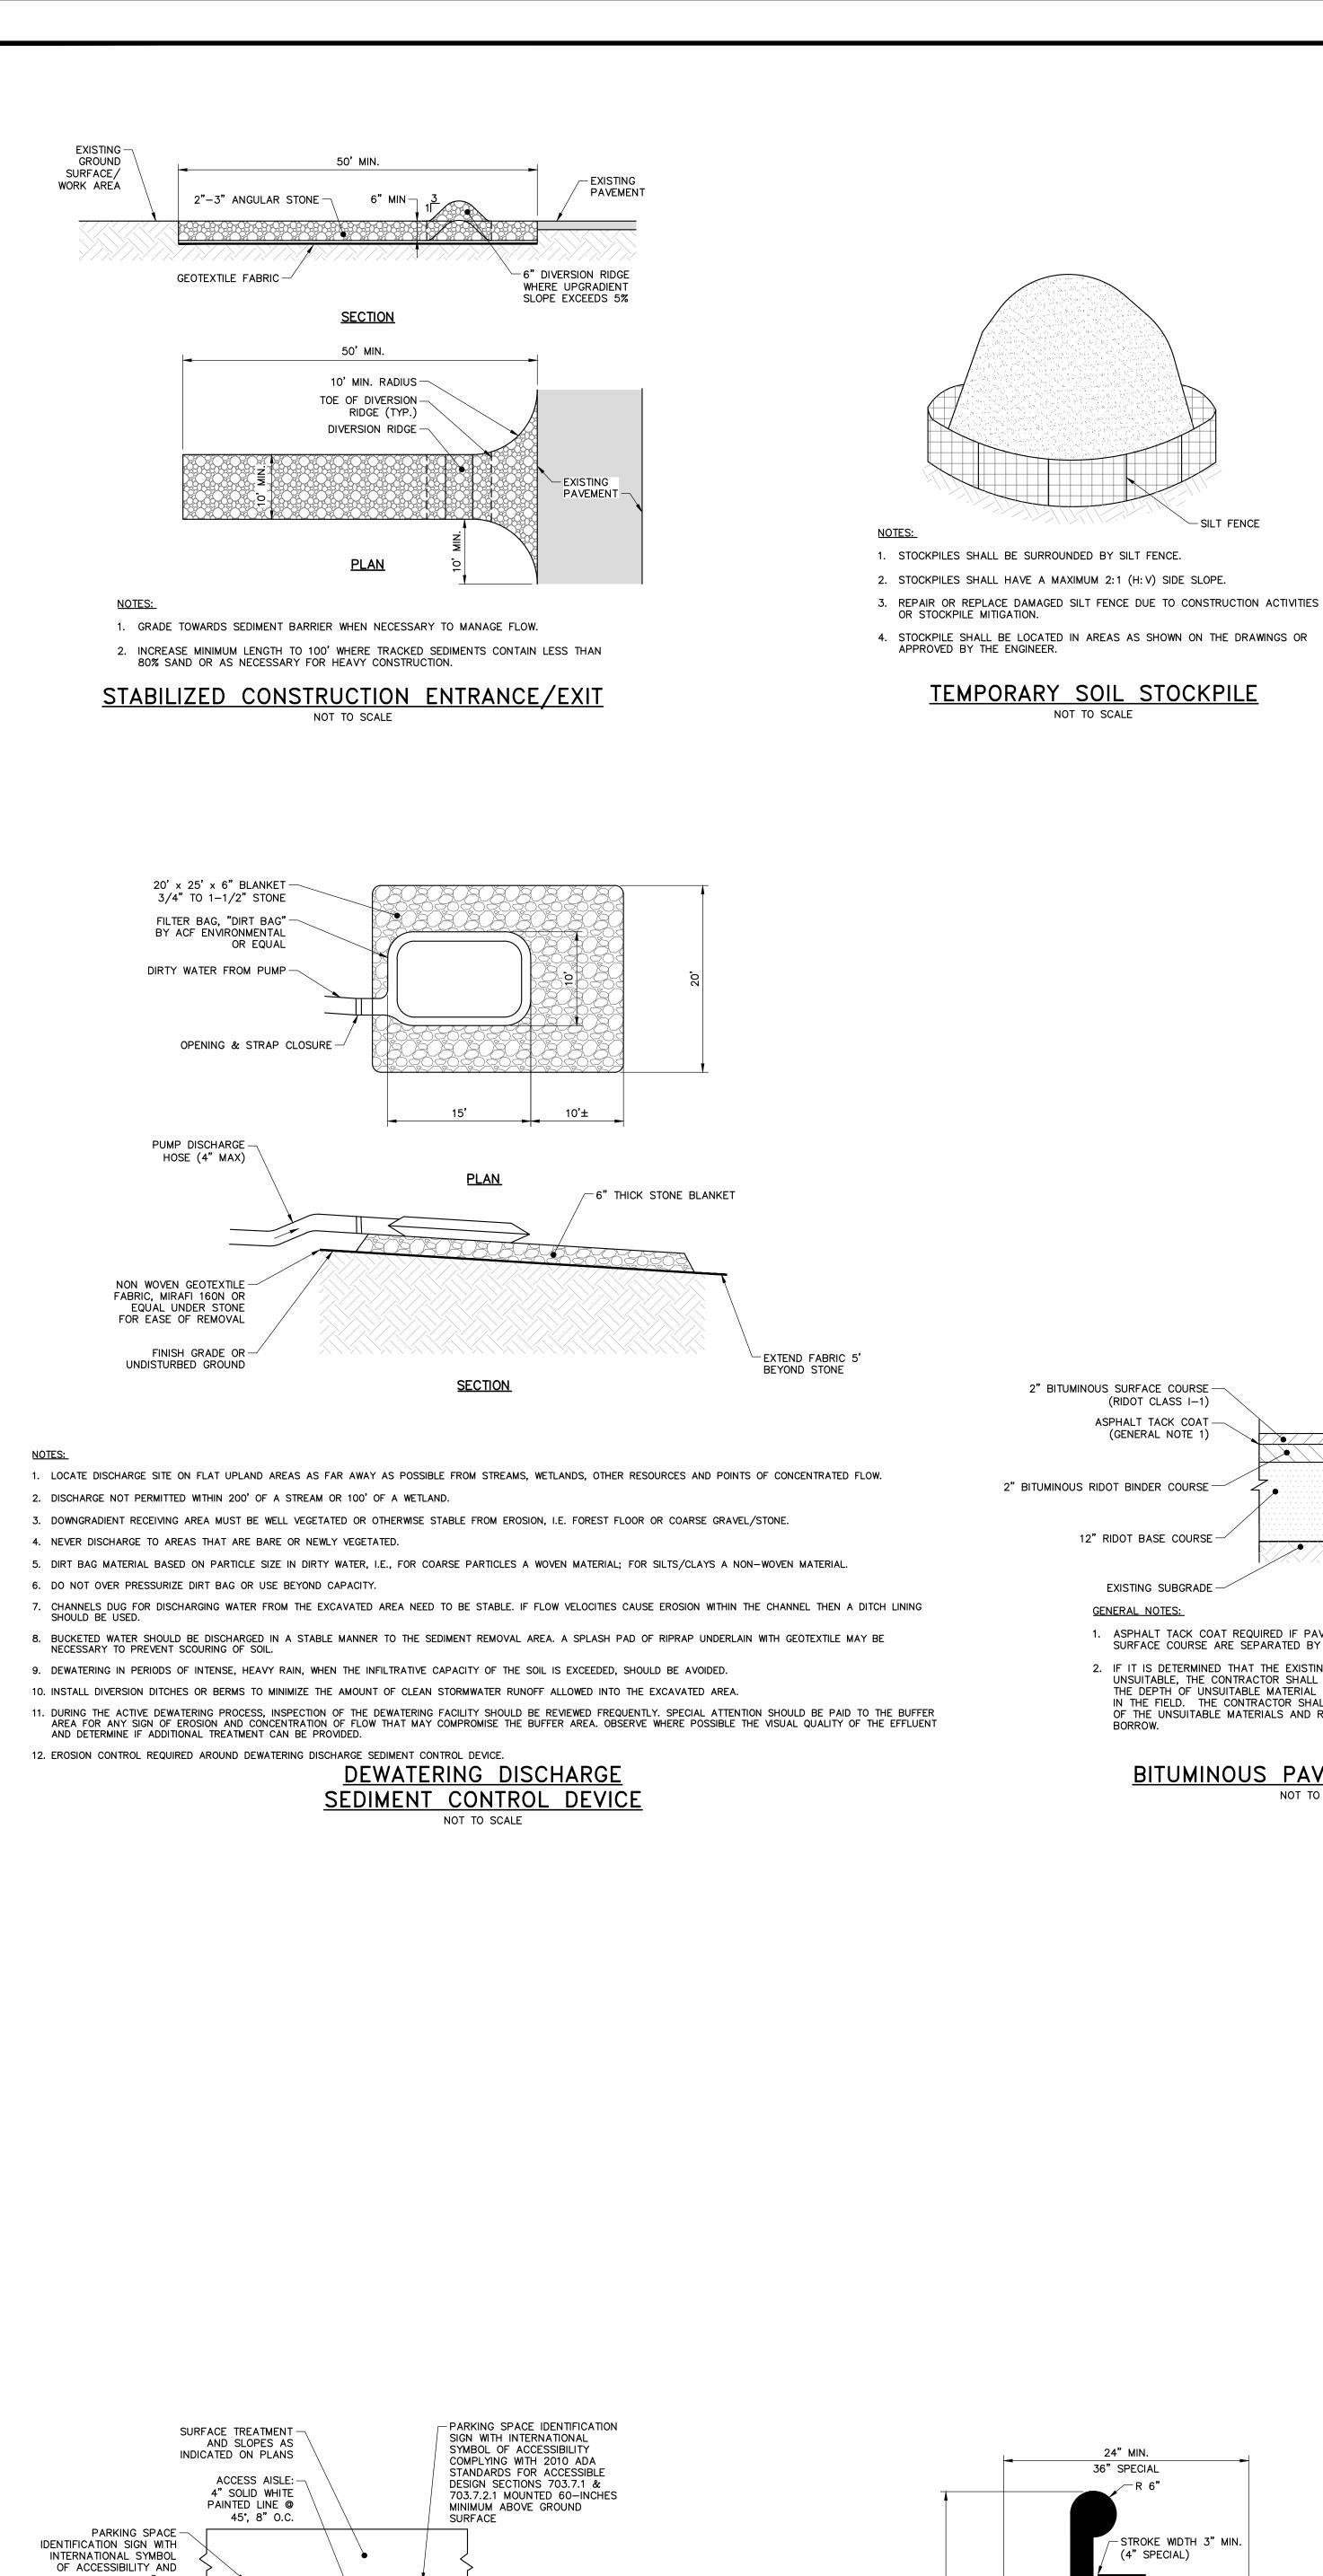



12" RIDOT BASE COURSE -

EXISTING SUBGRADE -

1. ASPHALT TACK COAT REQUIRED IF PAVING OF BINDER COURSE AND

2. IF IT IS DETERMINED THAT THE EXISTING SUBBASE MATERIALS ARE UNSUITABLE, THE CONTRACTOR SHALL IMMEDIATELY NOTIFY THE ENGINEER.

THE DEPTH OF UNSUITABLE MATERIAL TO BE REMOVED WILL BE DETERMINED

IN THE FIELD. THE CONTRACTOR SHALL REMOVE AND PROPERLY DISPOSE

OF THE UNSUITABLE MATERIALS AND REPLACE WITH COMPACTED GRAVEL


BITUMINOUS PAVEMENT SECTION

NOT TO SCALE

SURFACE COURSE ARE SEPARATED BY 30 DAYS OR MORE.

**GENERAL NOTES:** 

TEMPORARY SOIL STOCKPILE

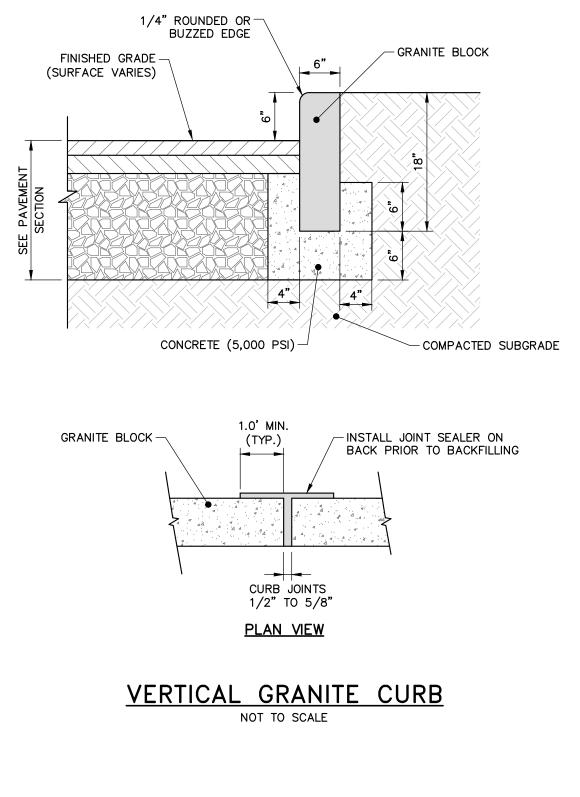

2"x2" WOODEN STAKE -

SILTSOCK (18" TYP.)

1. WHEN STAKING IS NOT POSSIBLE, HEAVY CONCRETE BLOCKS SHALL BE USED BEHIND THE

SILT SOCK

NOT TO SCALE

SEDIMENT CONTROL TO HELP STABILIZE DURING RAINFALL/RUNOFF EVENTS.

WORK AREA

<u>SECTION</u>

PROTECTED


LINEAL SPACING


PLAN VIEW

WORK AREA

WATER FLOW


AREA TO BE PROTECTED

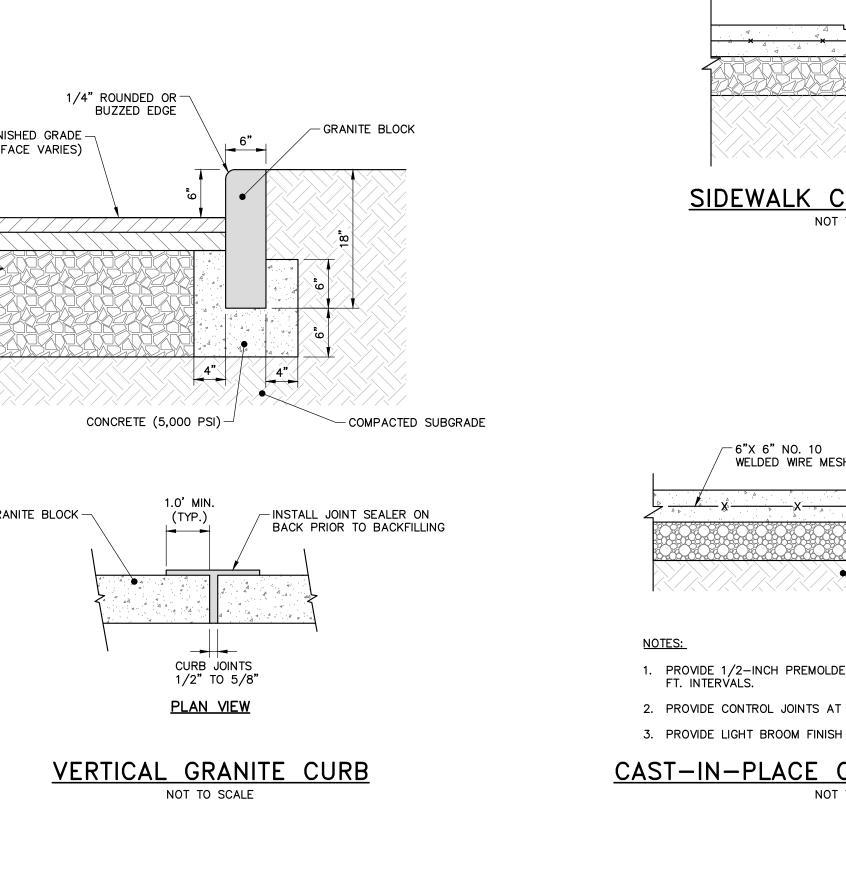

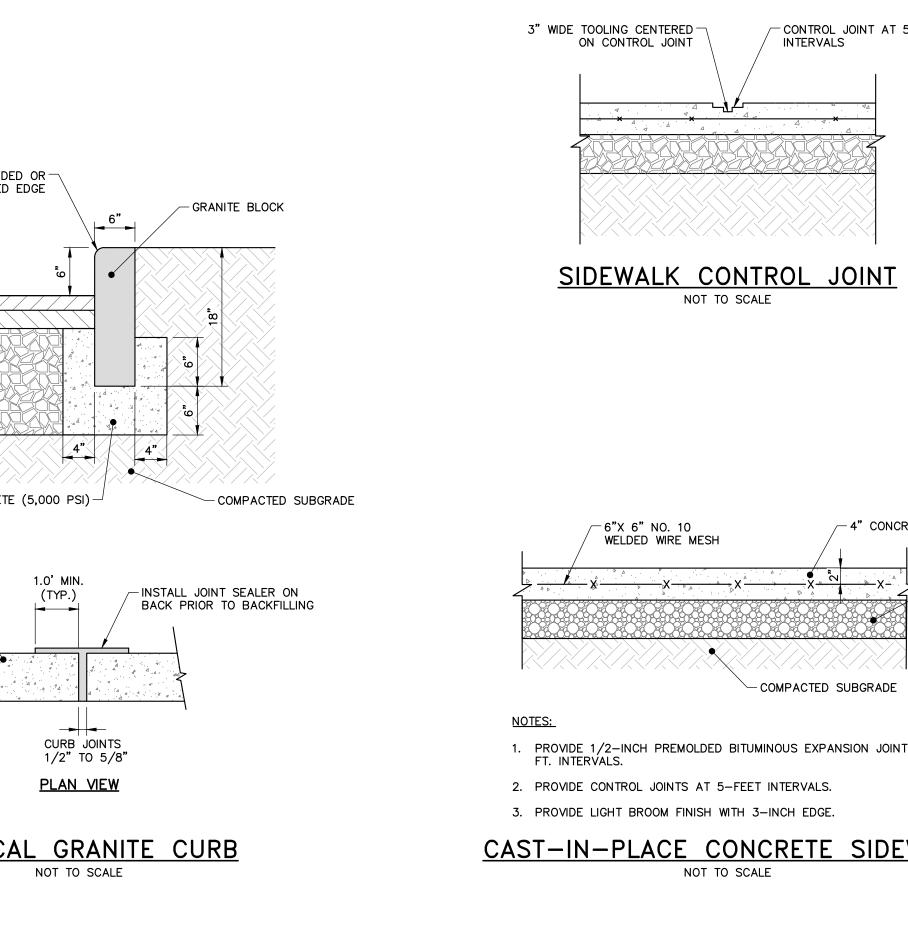

NOTES:

RECOMMENDATIONS.

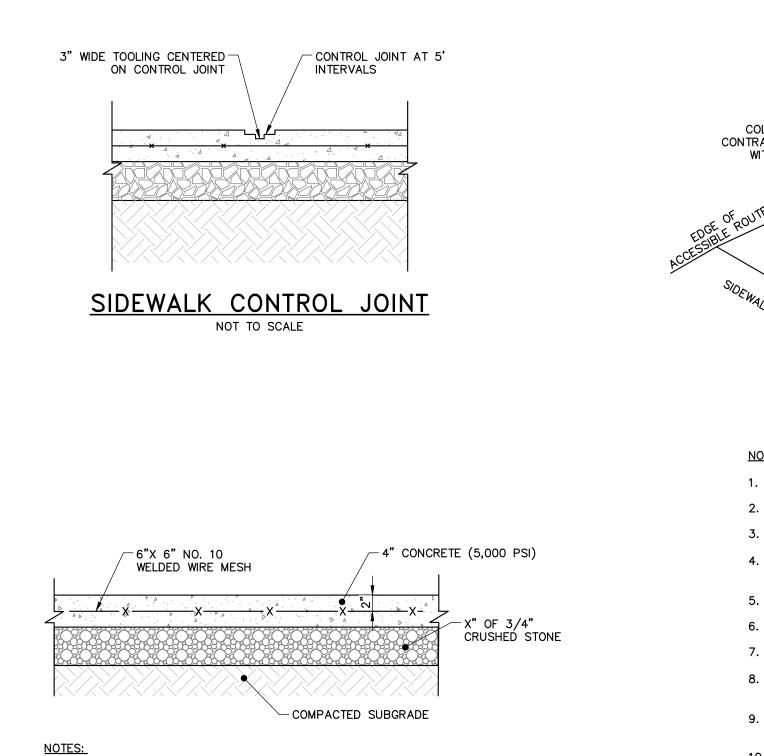

1" REBAR FOR LIFTING

AND REMOVAL

-DUMP STRAP TO

-SILT SACK

1. INSTALL SILTSACK PER MANUFACTURER'S INSTRUCTIONS AND

2. EMPTY OR REMOVE SEDIMENT FROM SILTSACK WHEN RESTRAINT CORD IS NO LONGER VISIBLE. CLEAN, RINSE, AND

SILT SACKS TO BE INSTALLED WHEN THE POTENTIAL FOR SEDIMENT TO ENTER EXISTING & PROPOSED BASINS EXISTS.


SILTSACK- CURBLESS INLET

NOT TO SCALE

FACILITATE EMPTYING


CURBLESS CATCH

BASIN STRUCTURE

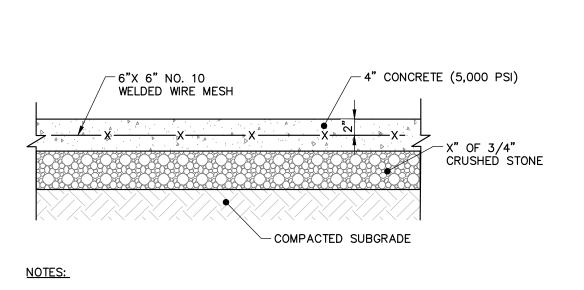

1. PROVIDE 1/2-INCH PREMOLDED BITUMINOUS EXPANSION JOINTS AT 20

CAST-IN-PLACE CONCRETE SIDEWALK

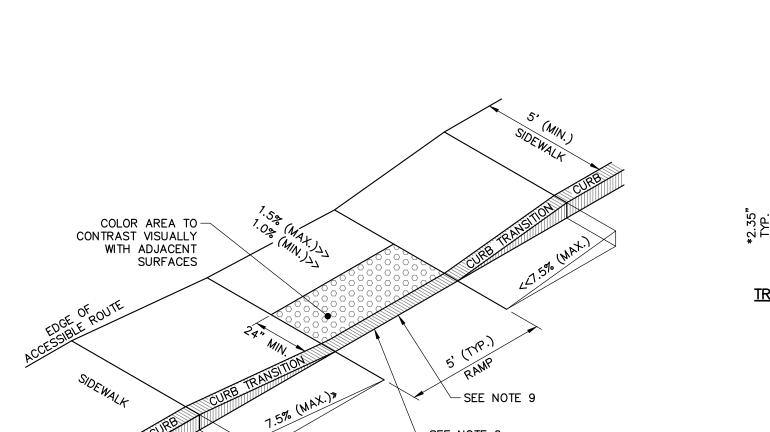


3. REMOVE SEDIMENT WHEN ACCUMULATION EXCEEDS 1/2 OF THE WET STORAGE VOLUME.

SEDIMENT STORAGE MARKER-

DRY STORAGE VOLUME

\_\_\_\_\_\_\_\_\_WET\_STORAGE\_VOLUME

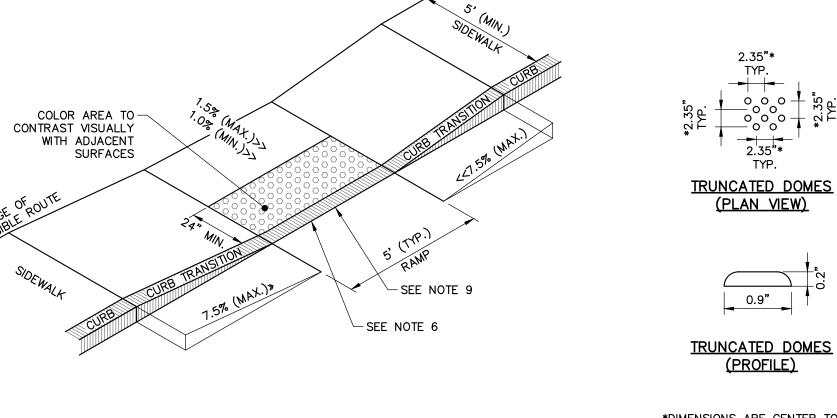

\_ \_ \_ \_ \_ \_ \_ \_ \_ \_ \_ \_ \_

TEMPORARY SEDIMENT TRAPS SHALL BE CONSTRUCTED AT THE START OF CONSTRUCTION PRIOR TO DISTURBANCE AND

2. BAFFLES CONSISTING OF STONE DIKES OR OTHER STRUCTURALLY SUFFICIENT BARRIERS SHOULD BE ADDED ALONG THE LONG

TYPICAL TEMPORARY SEDIMENT TRAP

INSTALLED PER THE RHODE ISLAND SOIL EROSION AND SEDIMENT CONTROL HANDBOOK. SEDIMENT SHALL BE REMOVED FROM THE BASINS AND PROPERLY DISPOSED OF UPON STABILIZATION OF THE SITE.

TRUNCATED DOMES \*DIMENSIONS ARE CENTER TO CENTER 1. THE MAXIMUM ALLOWABLE SIDEWALK AND CURB RAMP CROSS SLOPES SHALL BE 1.5% (1% MIN.) 2. THE MAXIMUM ALLOWABLE SLOPE OF ACCESSIBLE ROUTE EXCLUDING CURB RAMPS SHALL BE 5%. 3. THE MAXIMUM ALLOWABLE SLOPE OF ACCESSIBLE ROUTE CURB RAMPS SHALL BE 7.5%.

4.5' MAX.

-6" FILTER STONE

4. A MINIMUM OF 3 FEET CLEAR SHALL BE MAINTAINED AT ANY PERMANENT OBSTACLE IN ACCESSIBLE ROUTE (I.E. HYDRANTS, UTILITY POLES, TREE WELLS, SIGNS, ETC.) 5. BASE OF RAMP SHALL BE GRADED TO PREVENT PONDING.


6. ADJACENT SURFACES AT TRANSITIONS SHALL BE FLUSH WITH CURB RAMPS. 7. SEE TYPICAL SIDEWALK SECTION FOR RAMP CONSTRUCTION. 8. WHERE ACCESSIBLE ROUTES ARE LESS THAN 5' IN WIDTH (EXCLUDING CURBING) A 5'x5' PASSING AREA SHALL BE PROVIDED AT


INTERVALS NOT TO EXCEED 200 FEET. 9. ELIMINATE ALL CURBING AT RAMP (OTHER THAN VERTICAL CURBING, WHICH SHALL BE SET FLUSH) WHERE IT ABUTS ROADWAY OR OTHERWISE INDICATED.


10. DETECTABLE WARNING SHALL CONTRAST VISUALLY WITH ADJOINING SURFACES. 11. TRUNCATED DOMES AND ALL RELATED INSTALLED SURFACES TO BE INSTALLED ACCORDING TO MANUFACTURER'S SPECIFICATIONS. ALL DETECTABLE WARNING SURFACE INSTALLATIONS SHALL BE AT A MINIMUM AT LEAST AS NON SKID AS THE SURROUNDING PEDESTRIAN

12. FOR ALLOWABLE SLOPE OF ACCESSIBLE ROUTE ON EXISTING SITE, SEE SECTION 405 OF THE ADA STANDARD FOR ACCESSIBLE DESIGN.

ACCESSIBLE CURB RAMP (ACR) - TYPE 'A'

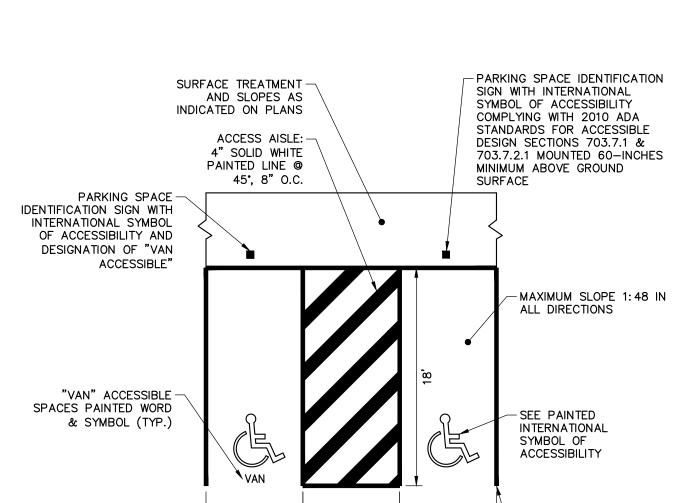


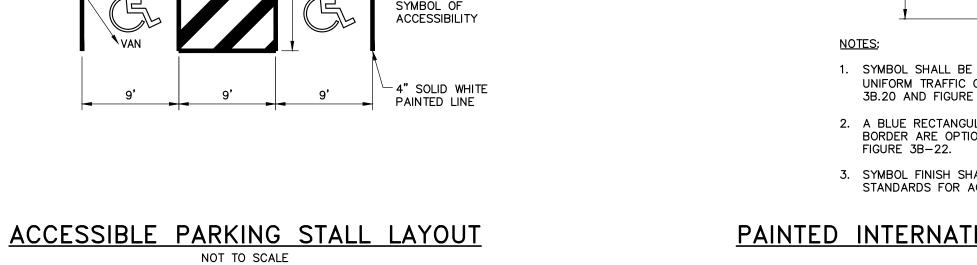

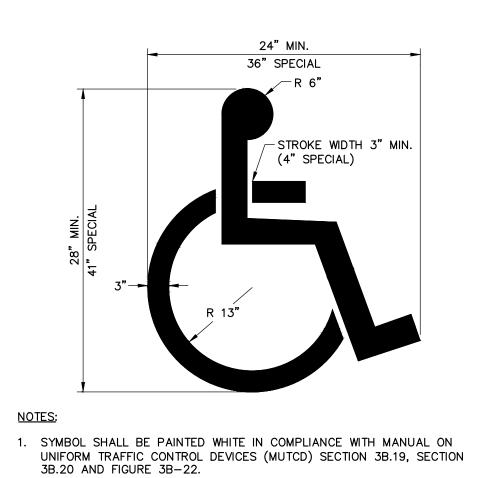



2. A BLUE RECTANGULAR (MIN. 36" X 36") BACKGROUND AND WHITE BORDER ARE OPTIONAL IN ACCORDANCE WITH MUTCD SECTION 3B.19 AND FIGURE 3B-22. 3. SYMBOL FINISH SHALL BE NON-GLARE IN ACCORDANCE WITH ADA STANDARDS FOR ACCESSIBLE DESIGN SECTION 703.7.1.

PAINTED INTERNATIONAL SYMBOL OF ACCESSIBILITY

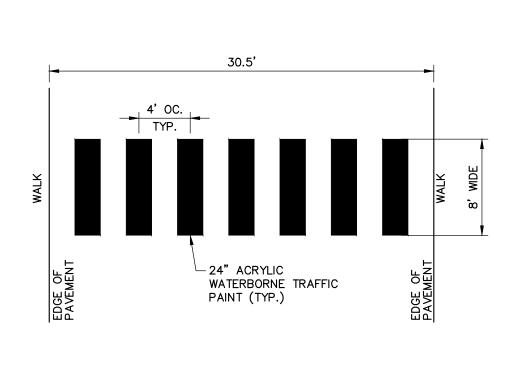

CROSSWALK PAVEMENT MARKING

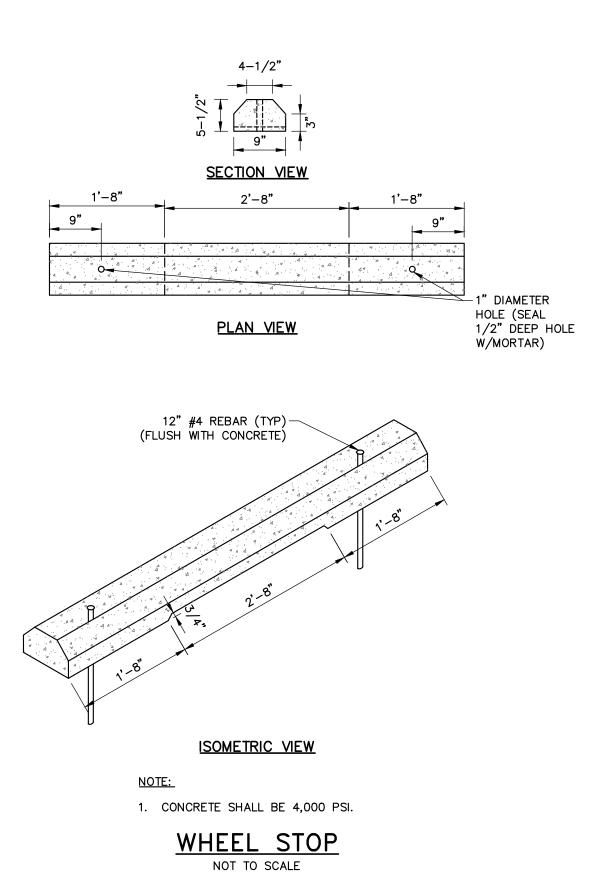

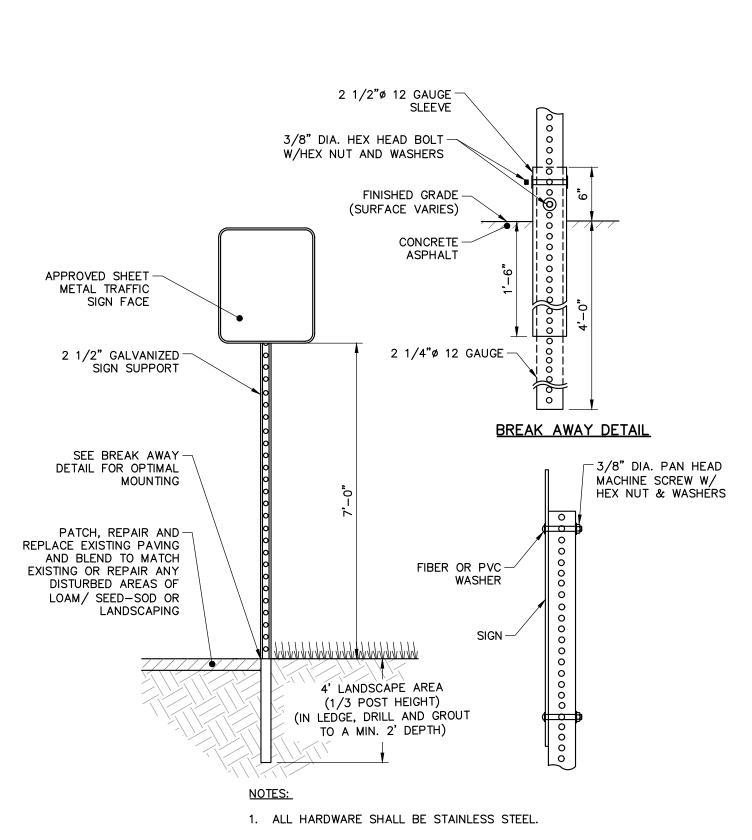

FOR ALL ABBREVIATIONS, SYMBOLS LEGENDS, AND GENERAL NOTES SEE SHEET C-000 **KEY PLAN** SCALE: AS NOTED NORTH A Taco Family Company **NEW INDUSTRIAL** MANUFACTURING AND WAREHOUSING FACILITY FOR TACO COMFORT SOLUTIONS, INC. 35 CARLSBAD STREET, CRANSTON, RI 02920 PROJECT NUMBER: 2022-077 **DRAWN BY: KCC** REVIEWED BY: CG **CIVIL DETAILS 1** 

PERMITTING SET DESCRIPTION

SUE DATE:

6/12/2024

REVISIONS:

DATE

**COMPASS GROUP** 

ARCHITECTURE LLC

4 CAUSEWAY ROAD ASSONET, MA 02702

TEL: (508)-644-8017

CELL:(774)-244-1101 COMPASSGROUPARCH.COM


Woodard


& Curran

CONSULTANT

PROFESSIONAL ENGINEER



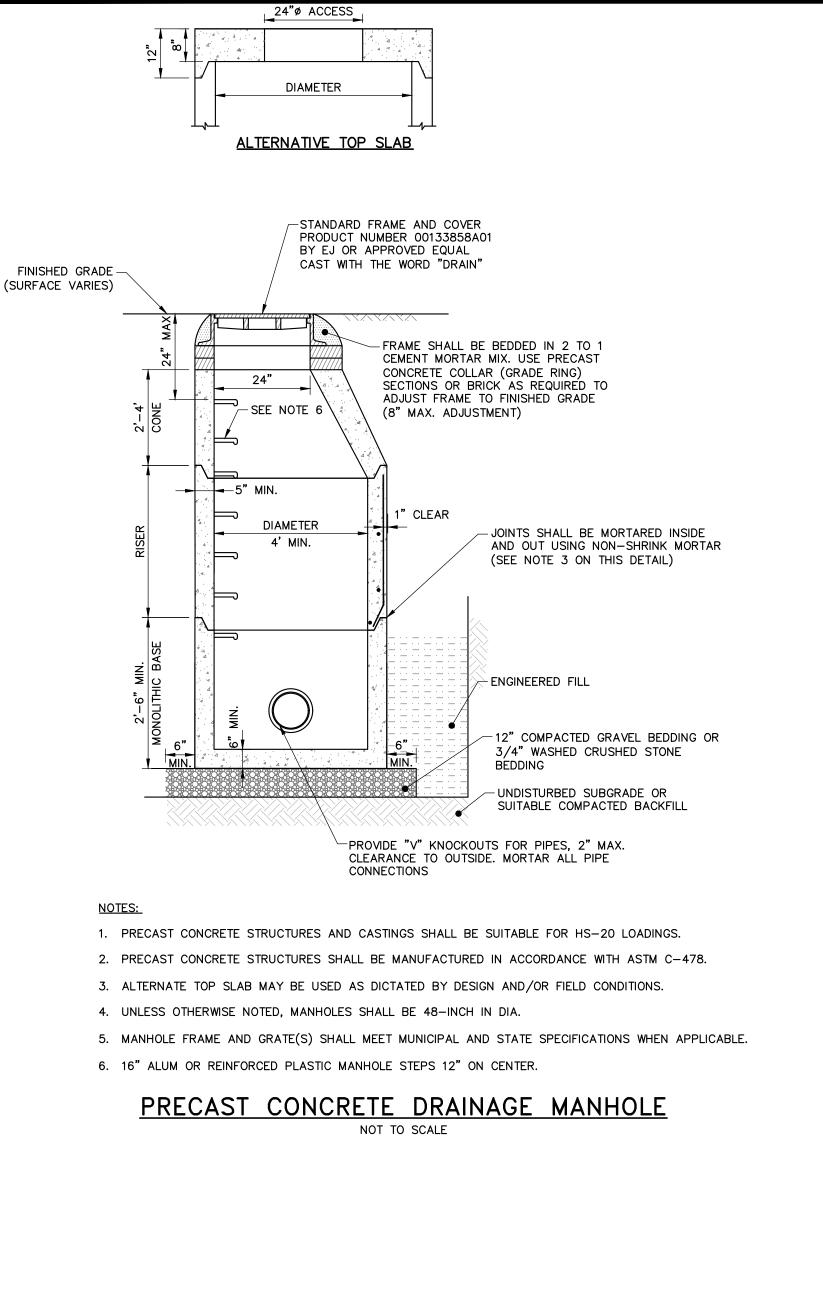

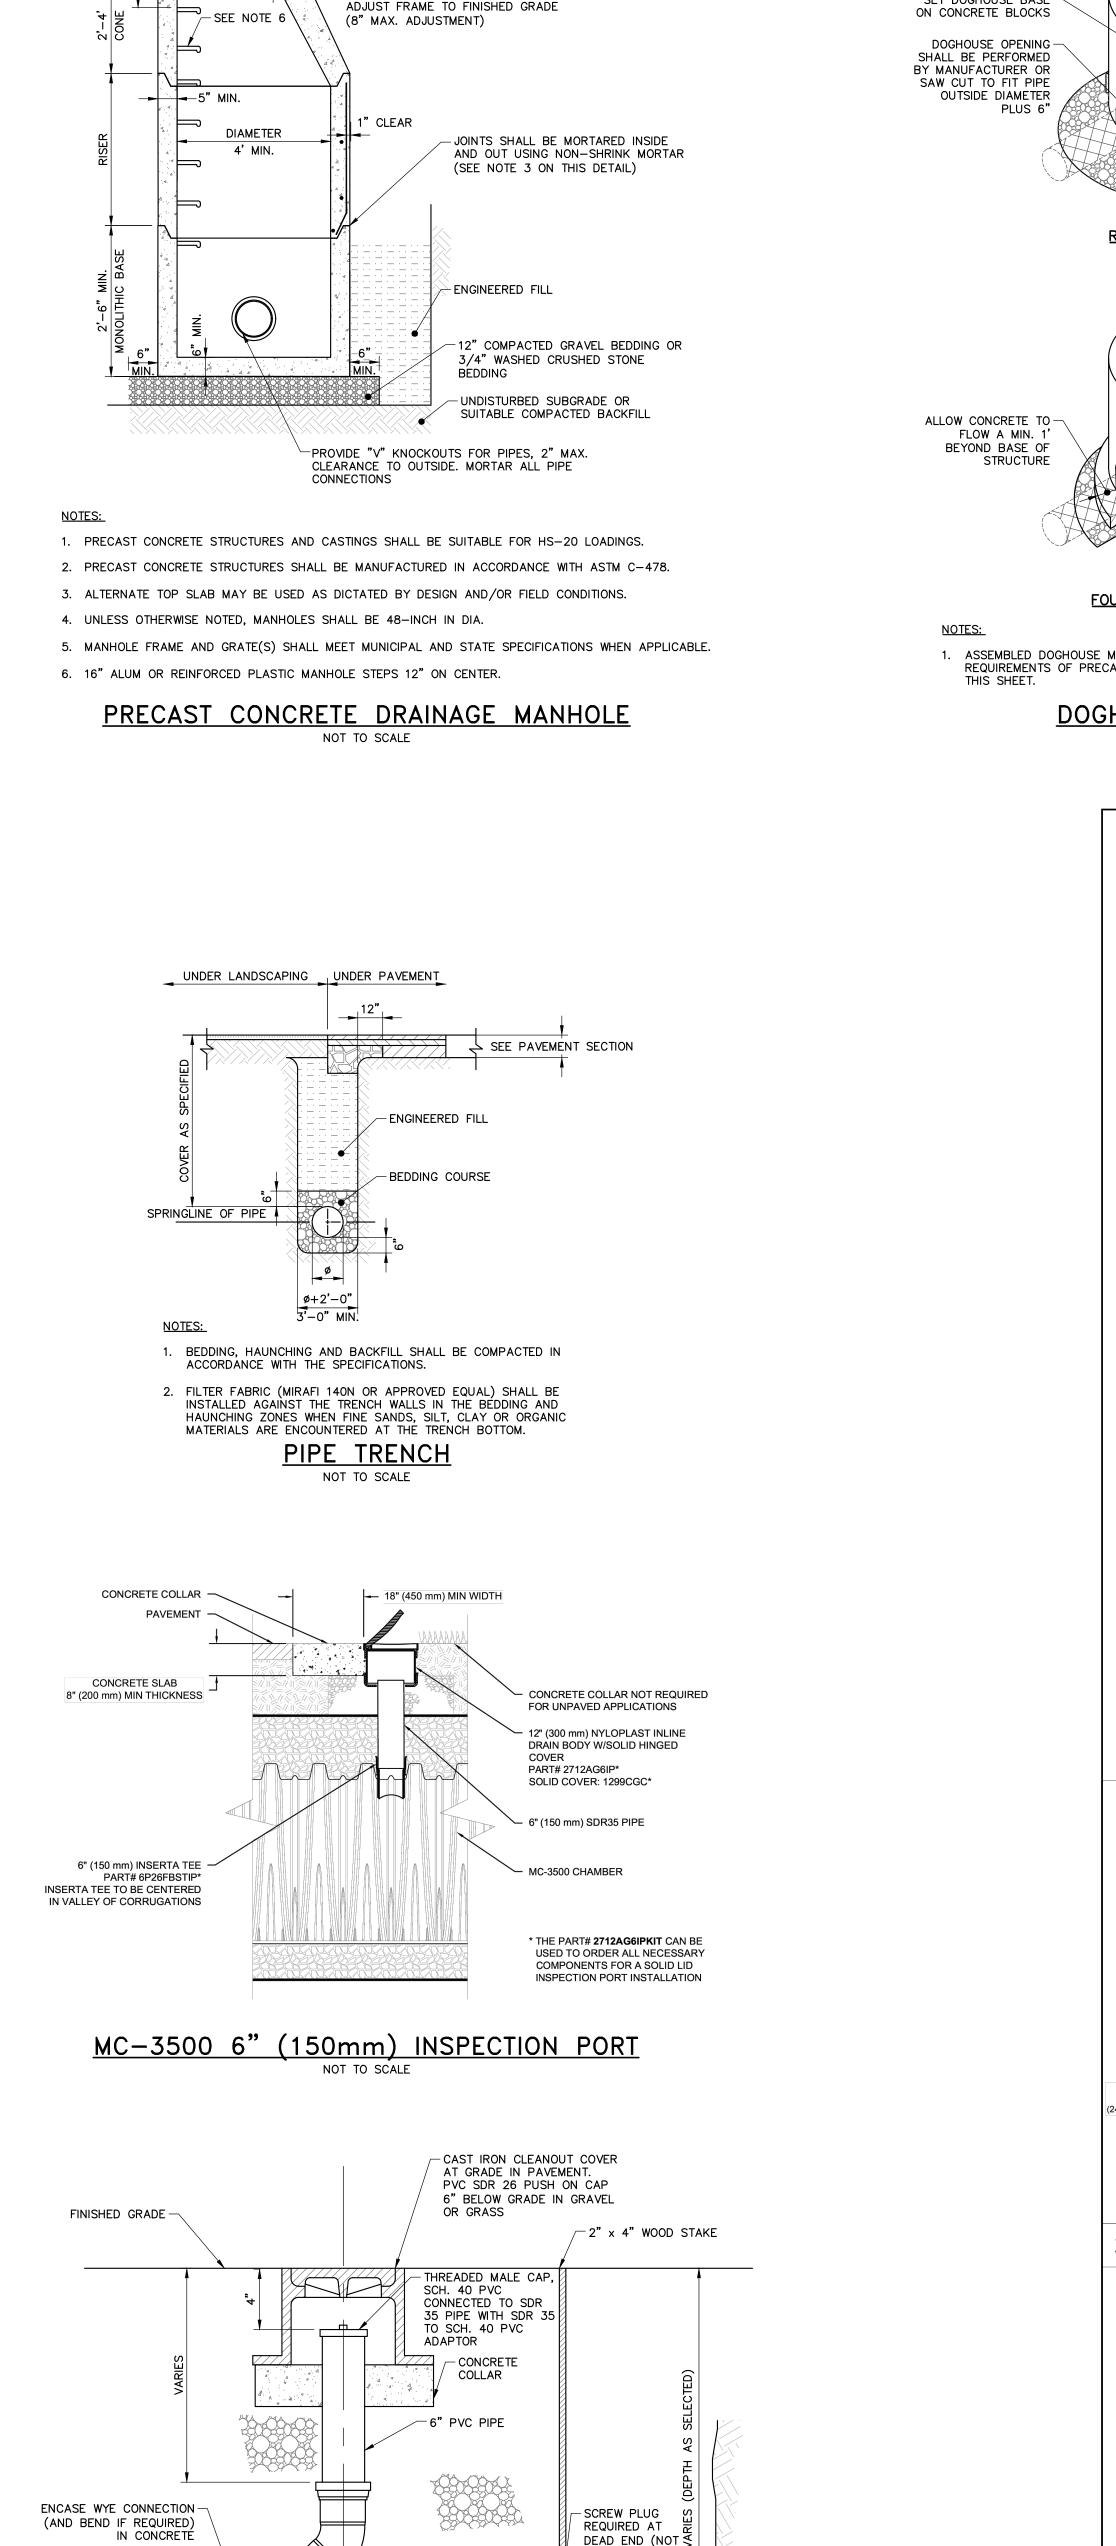

TO BE ENCÂSED

IN CONCRETE). II

NOT DEAD END,

EXTEND PIPING.

BEND AT END


LOCATIONS

FLOW

SANITARY SEWER CLEANOUT


PVC SANITARY SEWER PIPE OR BEND AS


ELIMINATE SCREW

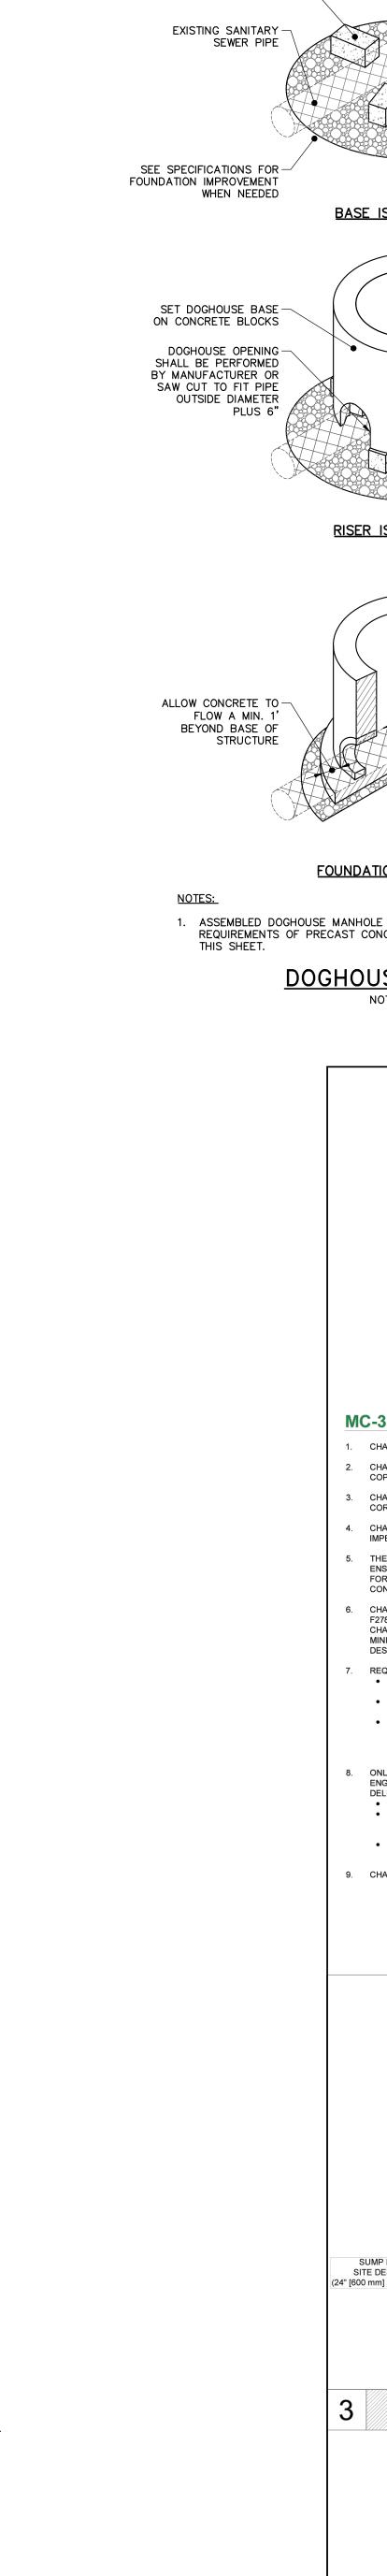

8X8X16 SOLID CONCRETE -BLOCK CENTER WITH

RISER WALL (4 EACH)

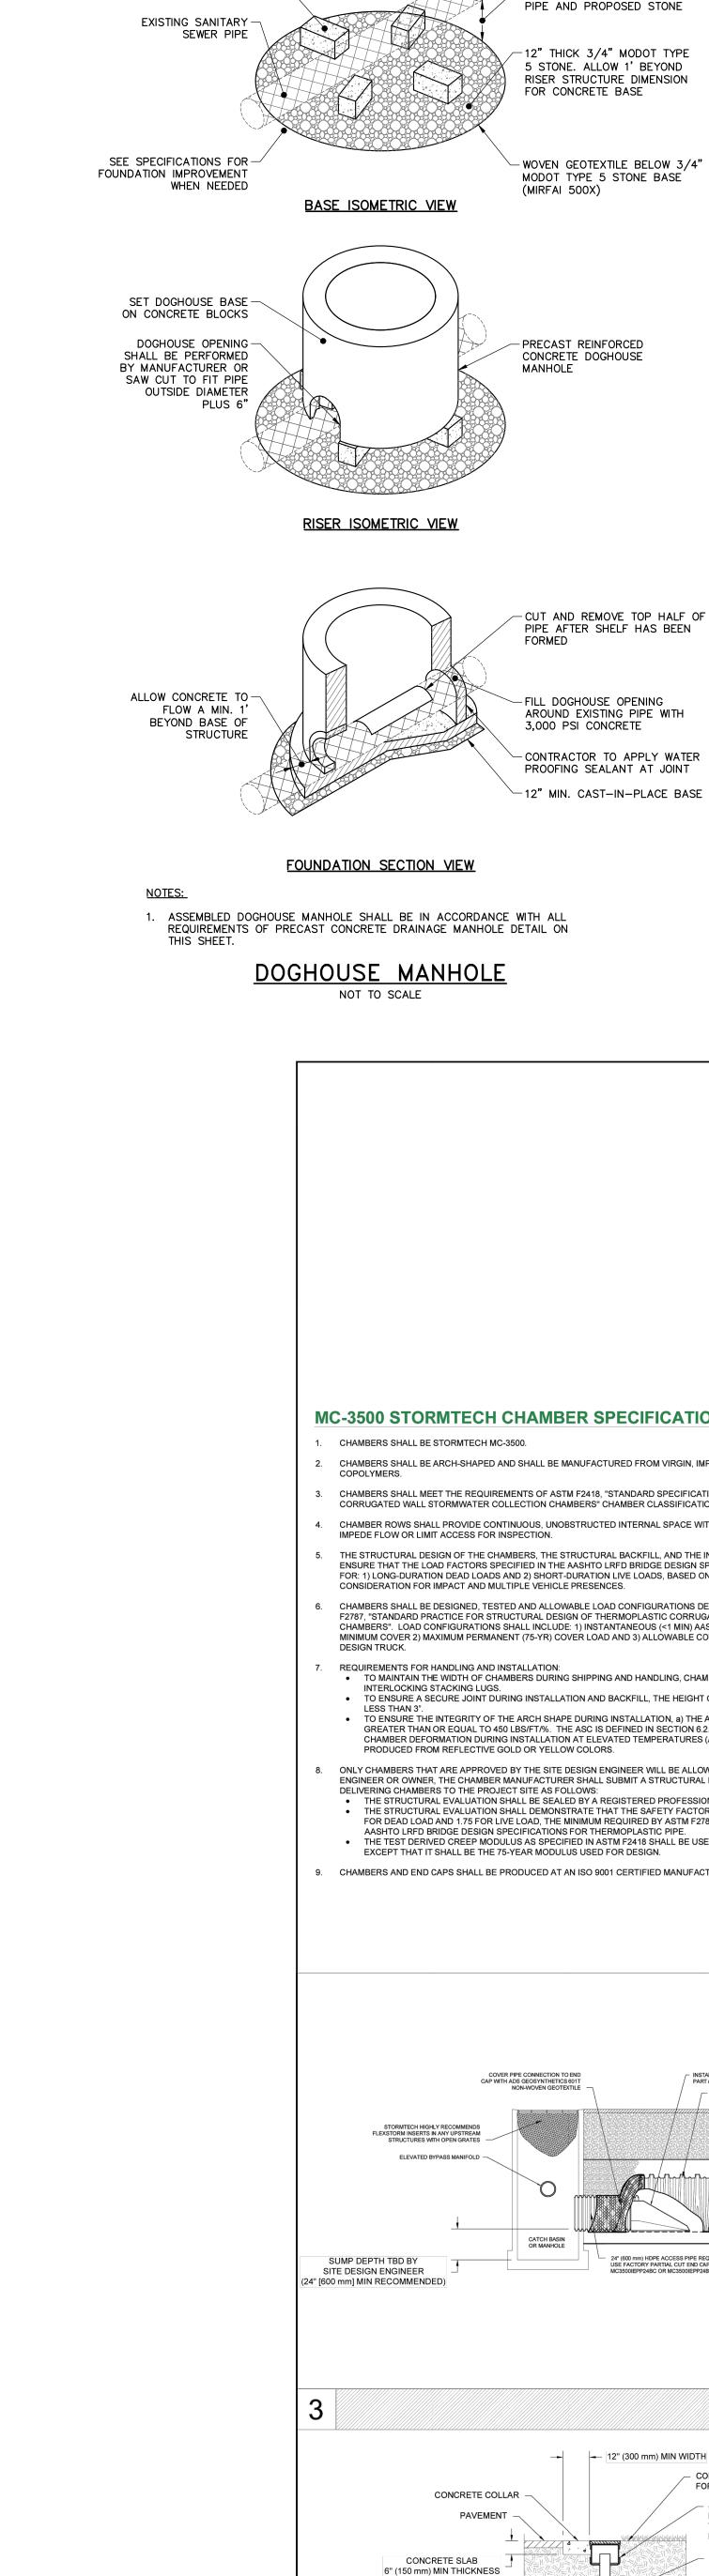

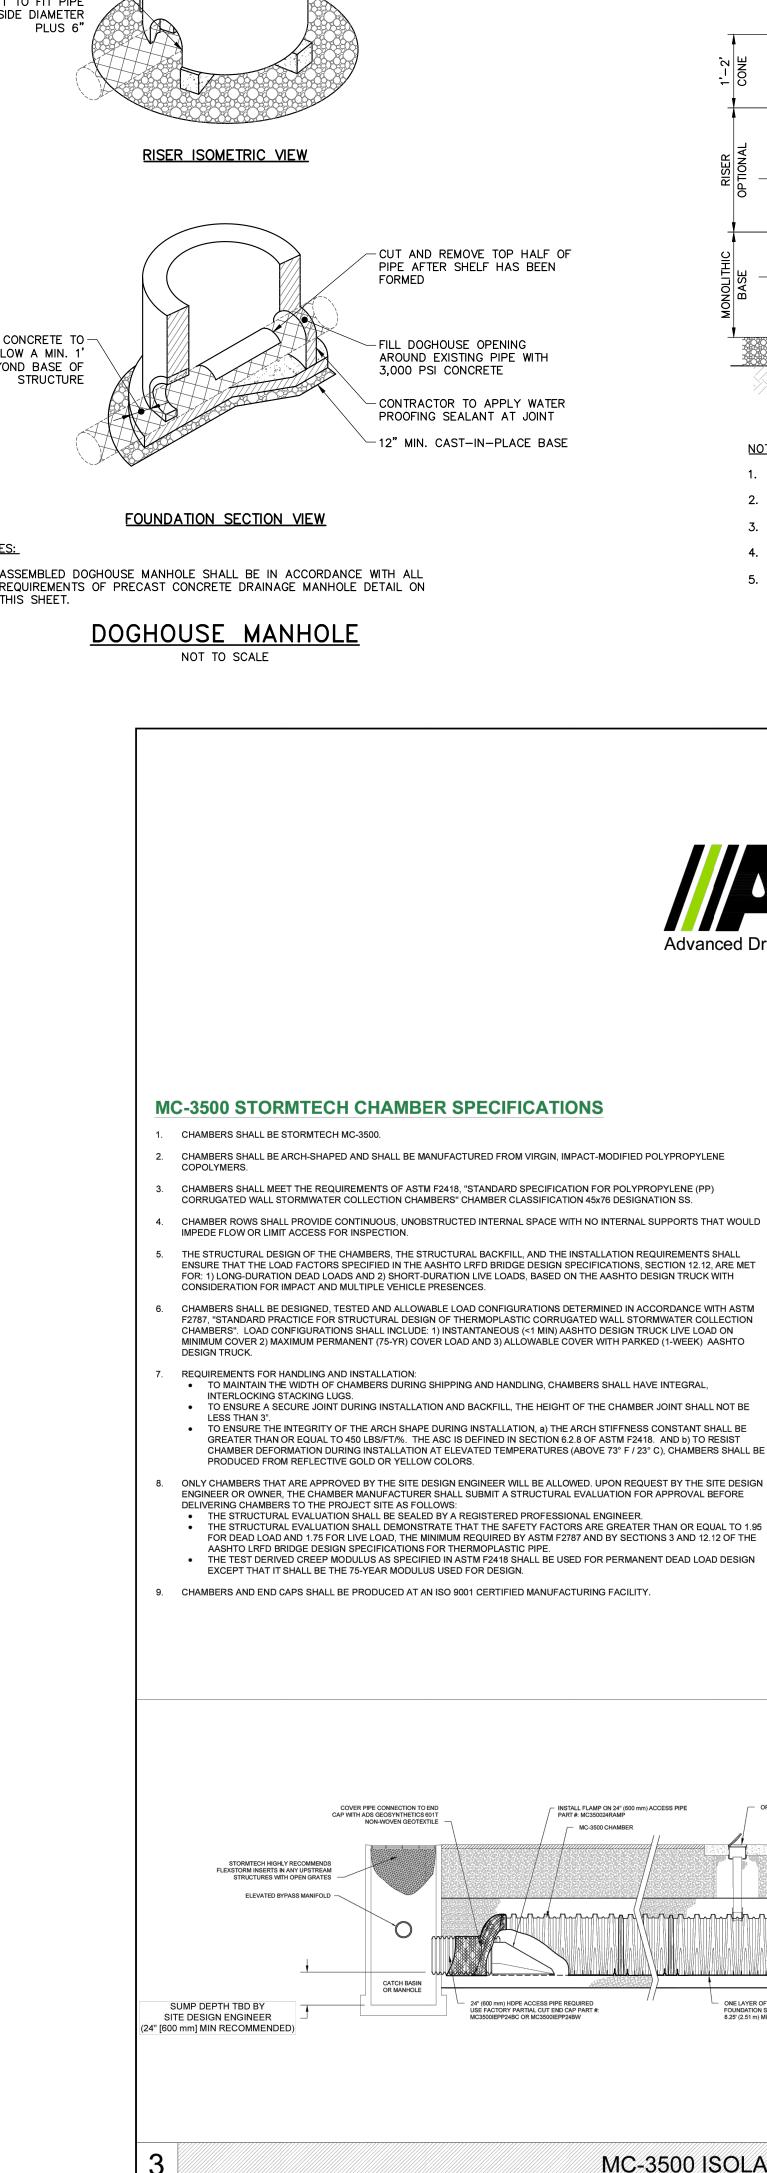

STORMTECH CHAMBER

SDR 35 PIPE

INSPECTION PORTS MAY BE CONNECTED THROUGH ANY CHAMBER CORRUGATION VALLEY.

4" PVC INSPECTION PORT DETAIL

(MC SERIES CHAMBER)

- MIN. 12" CLEAR BETWEEN EXISTING

FRAME AND GRATE (4 FLANGES)

PRODUCT NUMBERS:

DIAMETER 5

OPTIONAL -HOOD FRAME TO BE SET IN FULL MORTAR BED

- PRECAST CONCRETE CONCENTRIC CONE

 $\sim$  PROVIDE "V" KNOCKOUTS FOR PIPES, 2

- ENGINEERED FILL

MAX. CLEARANCE TO OUTSIDE. MORTAR ALL

-FINISHED GRADE

- ADJUST TO GRADE WITH BRICK OR

PRECAST CONCRETE RINGS (8"

MAX ADJUSTMENT)

(SURFACE VARIES)


4-FLANGE FRAME: 00552411 3-FLANGE FRAME: 00552311

BY EJ OR APPROVED EQUAL

MATCH PRODUCT LISTED ABOVE


SINGLE GRATE: 00552060

USE 3 FLANGES WHEN ADJACENT TO CURB

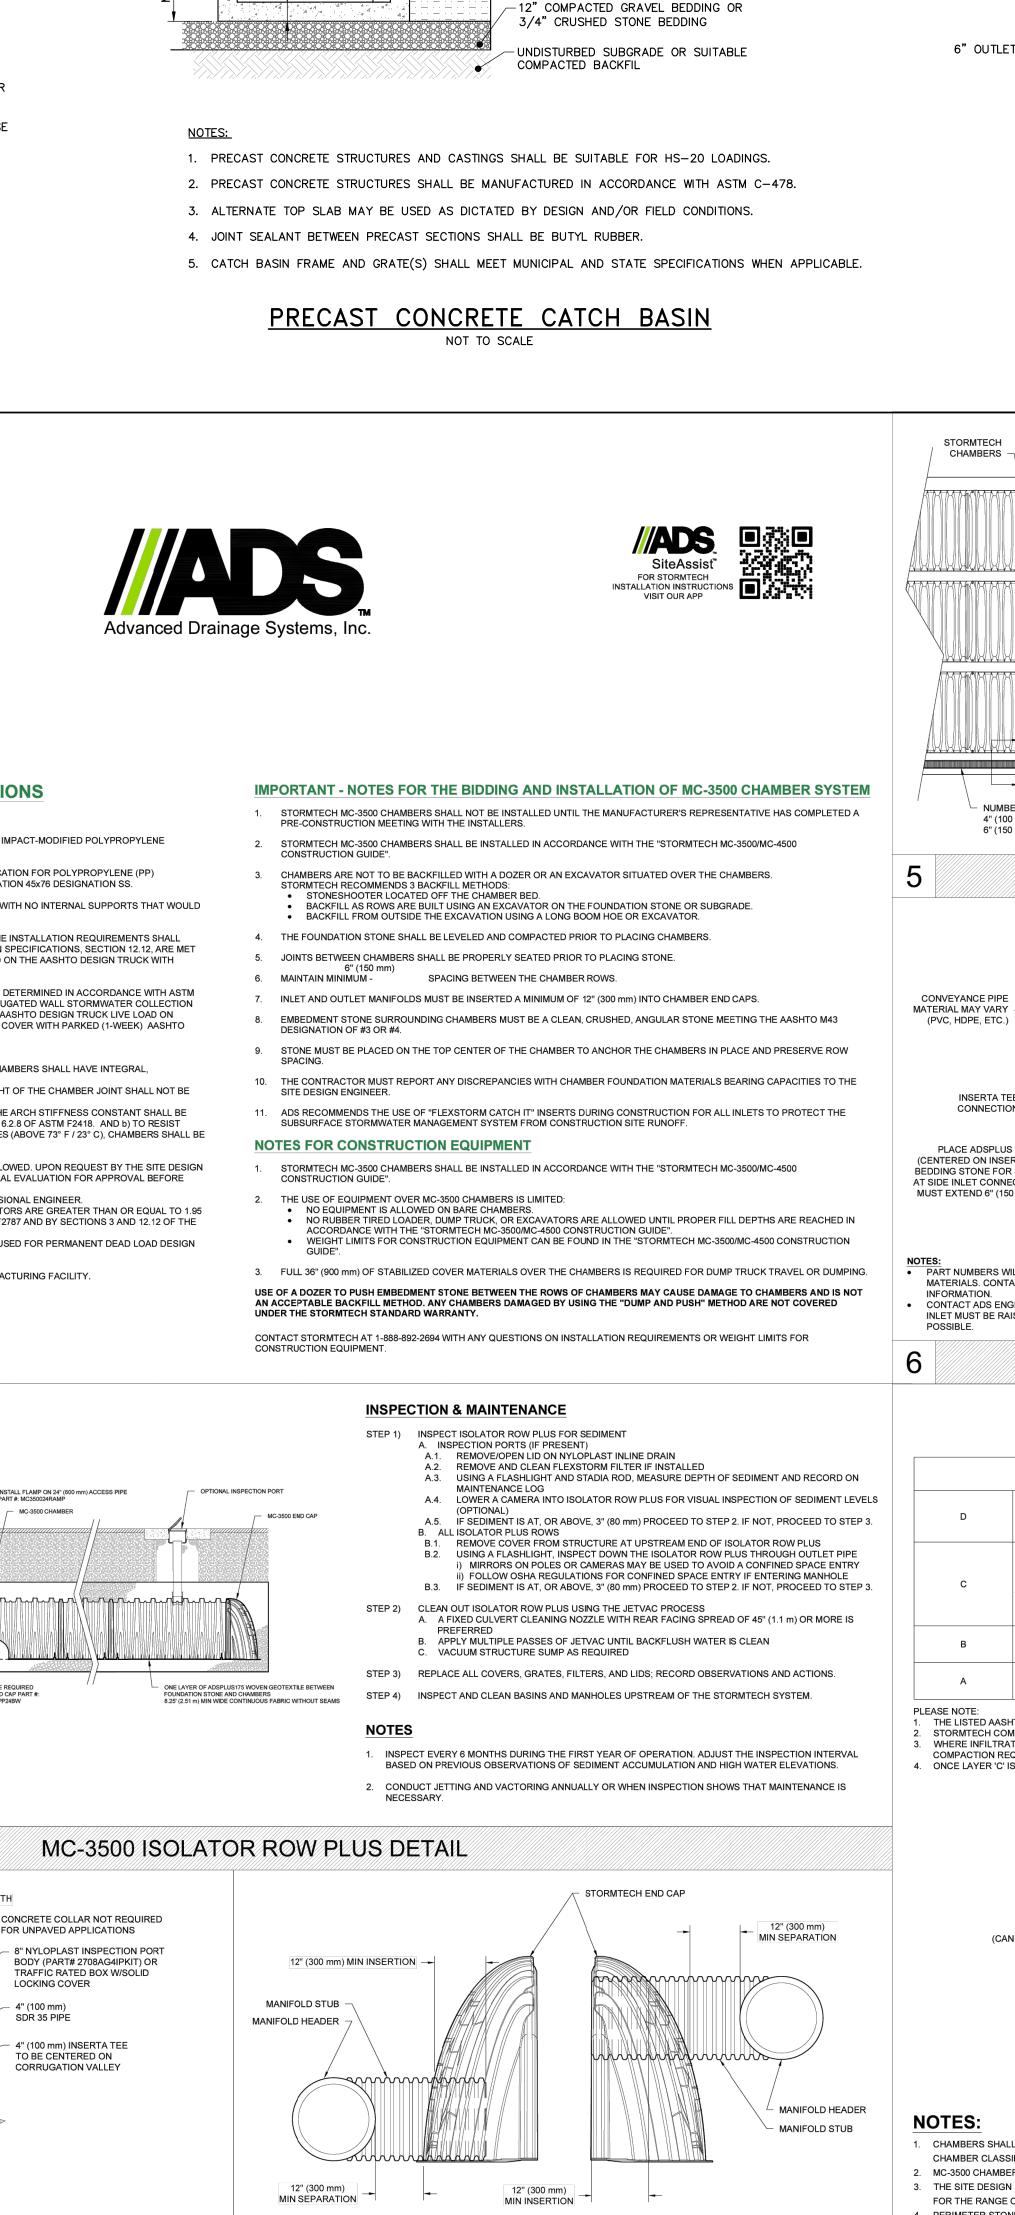

NOTE: MANIFOLD STUB MUST BE LAID HORIZONTAL FOR A PROPER FIT IN END CAP OPENING.


MC-SERIES END CAP INSERTION DETAIL

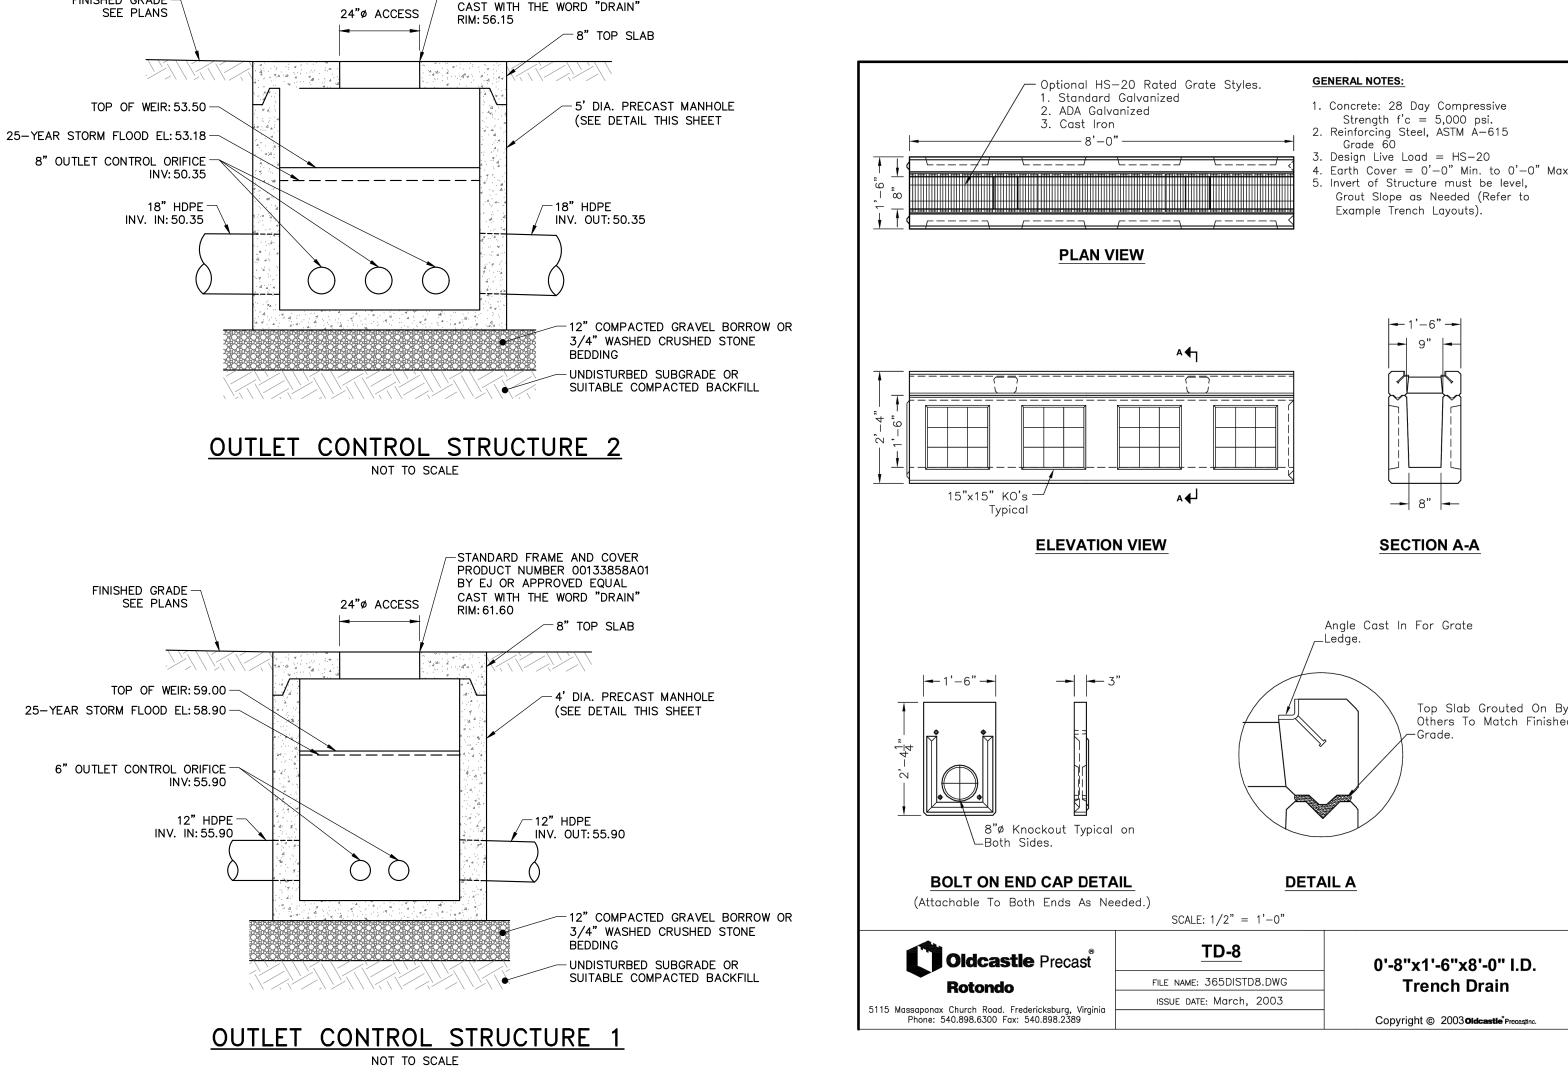



-STANDARD FRAME AND COVER

BY EJ OR APPROVED EQUAL

PRODUCT NUMBER 00133858A01

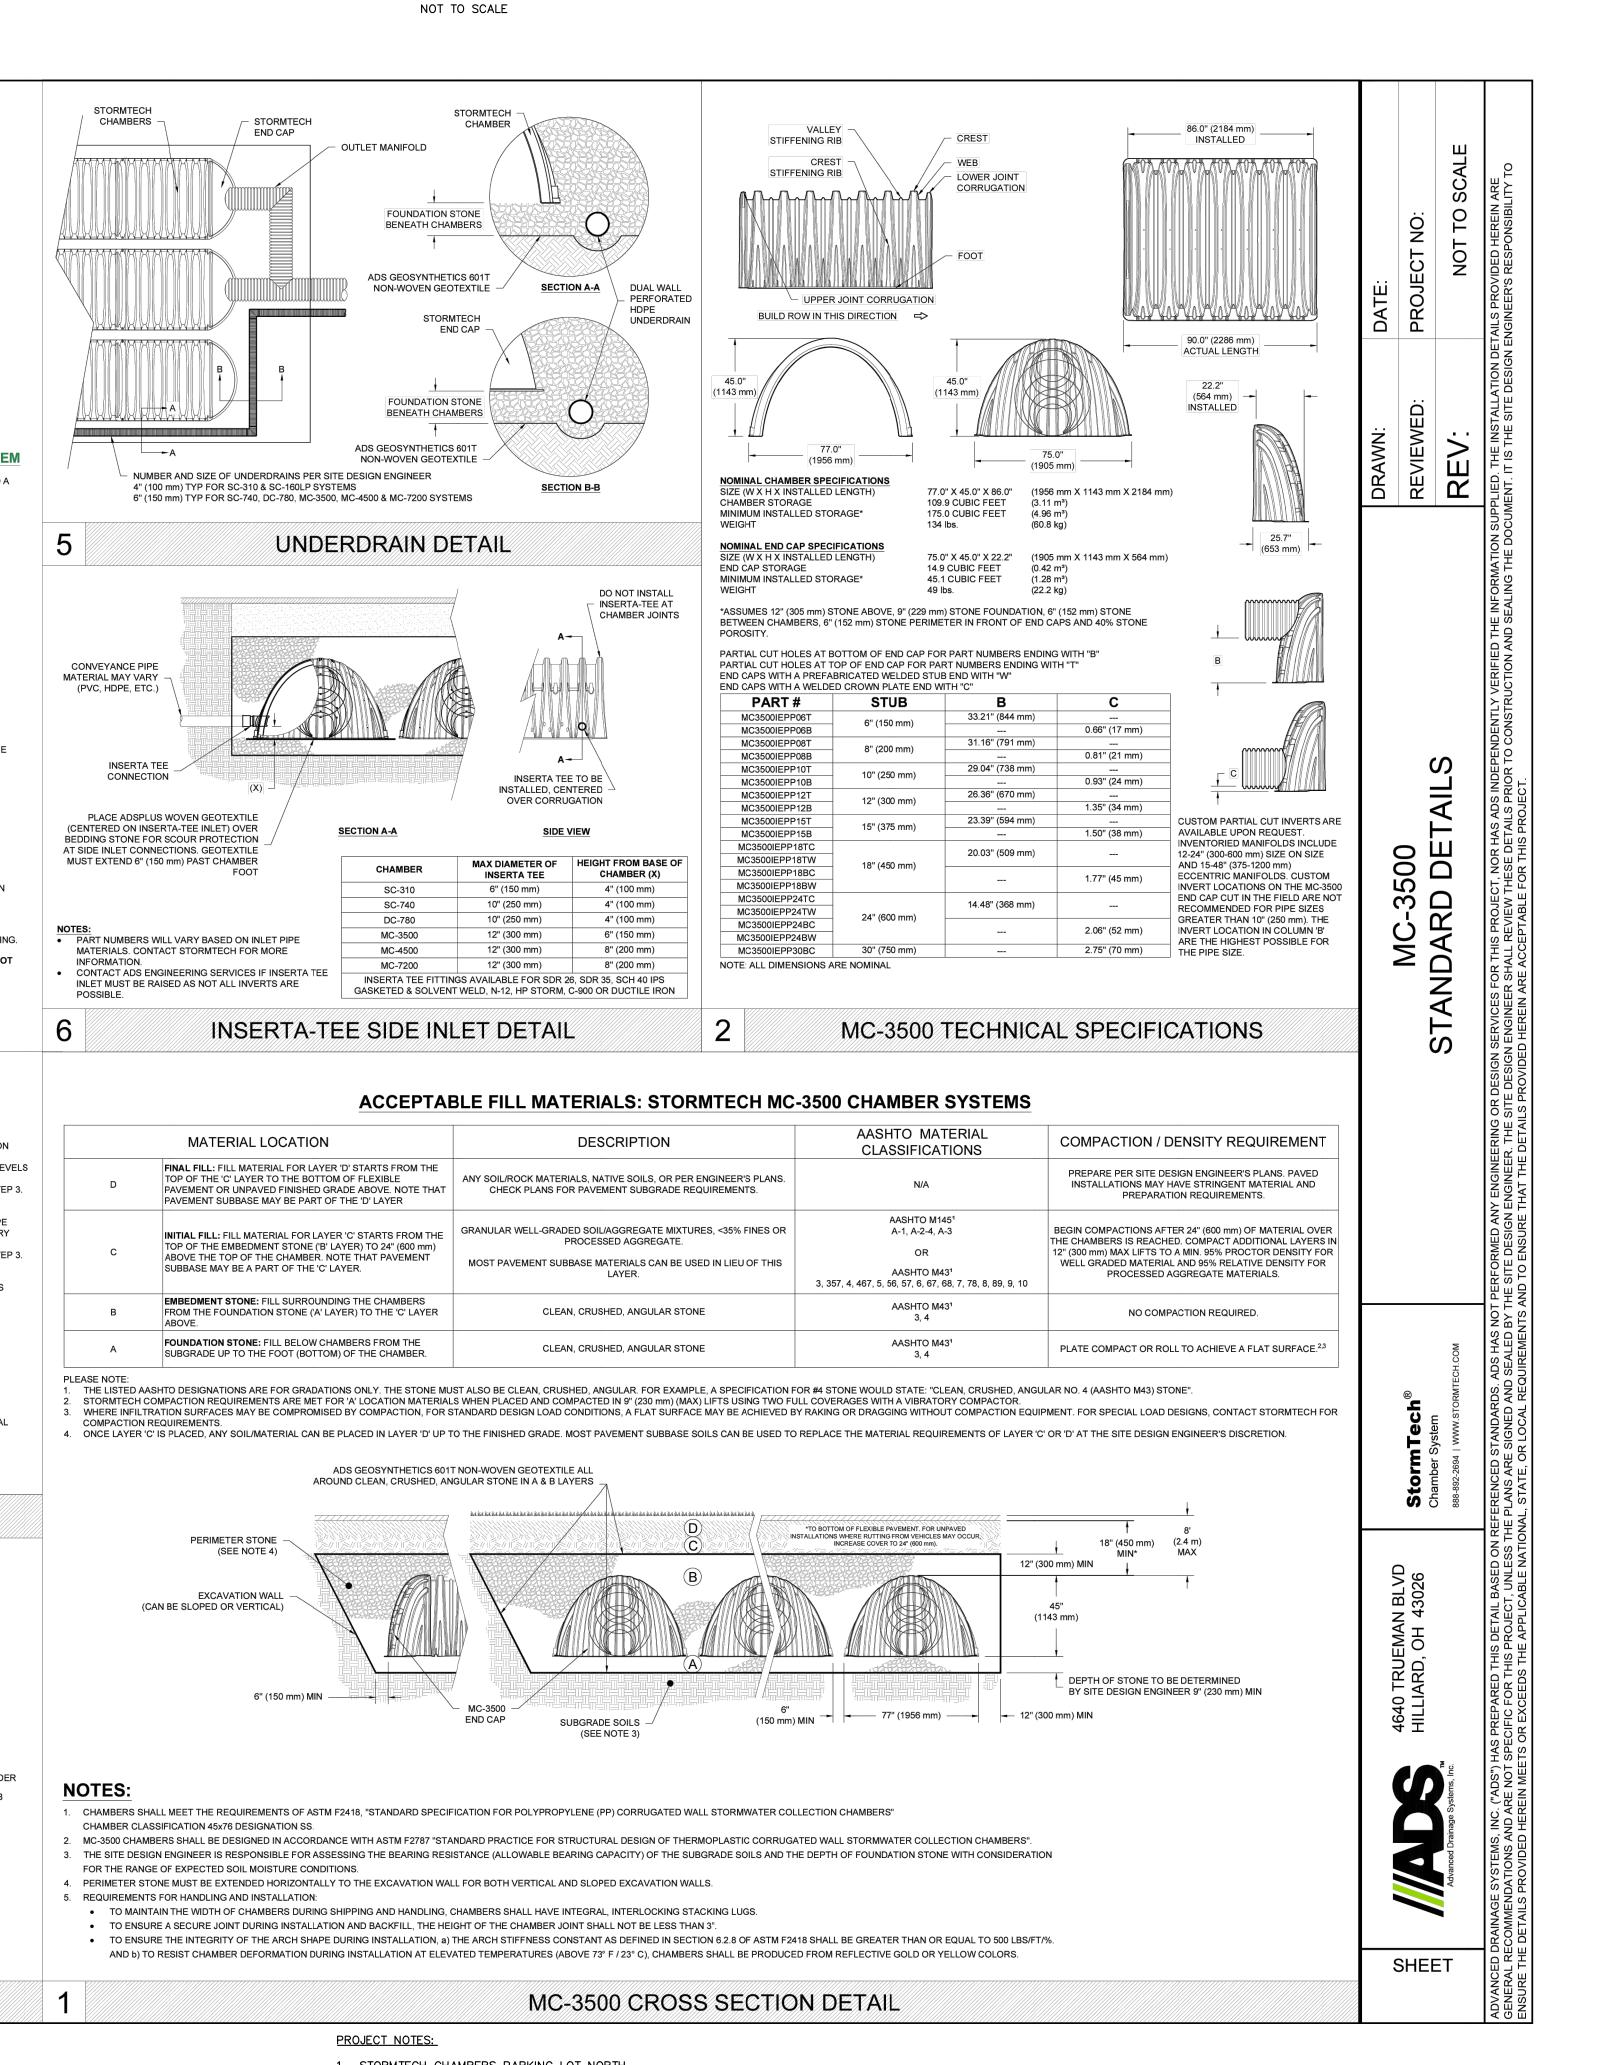

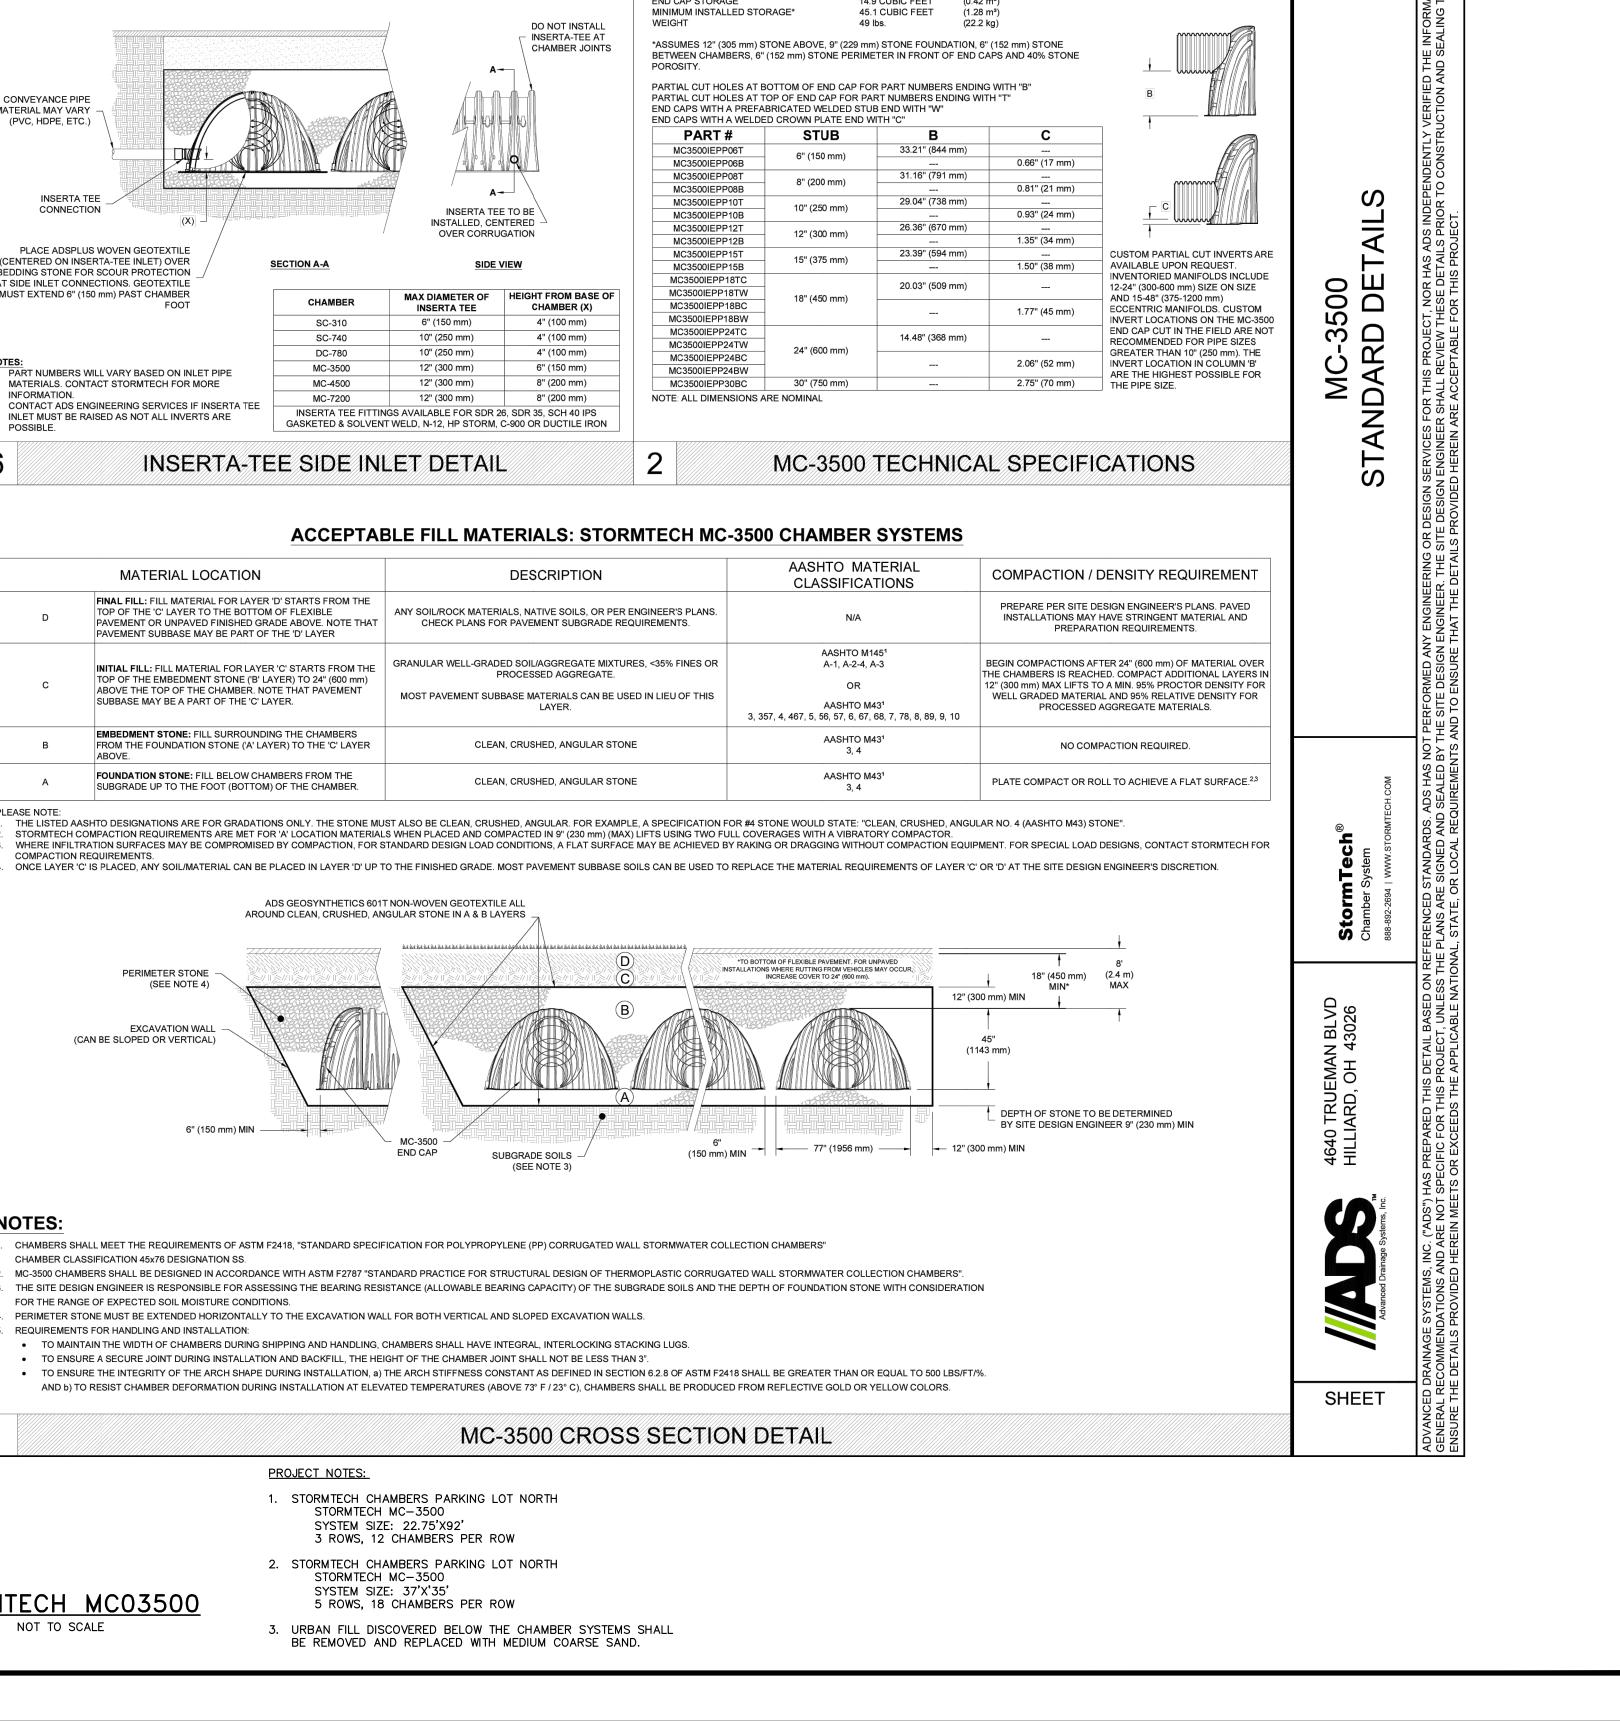

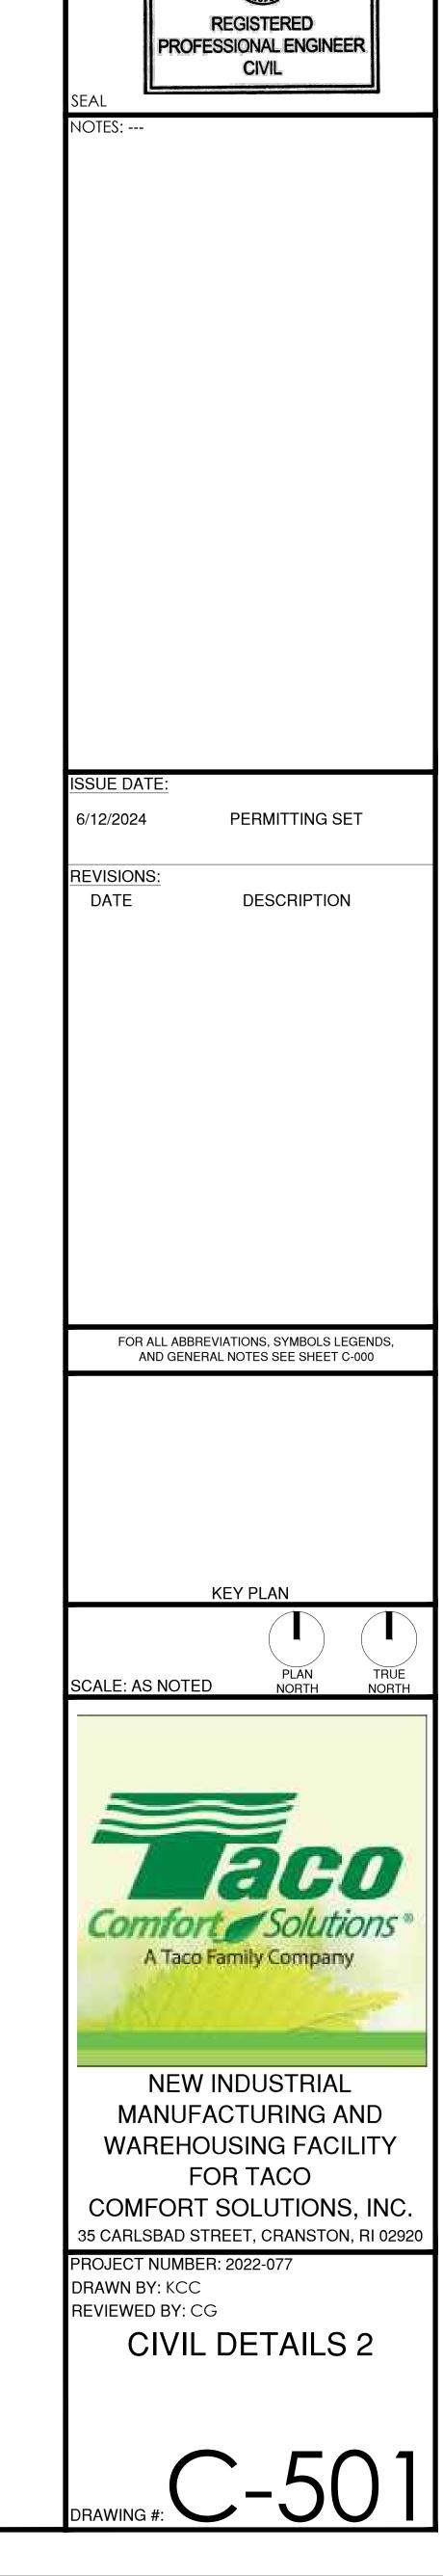

COMPASS GROUP

ARCHITECTURE LLC

4 CAUSEWAY ROAD

ASSONET, MA 02702

TEL: (508)-644-8017


CELL:(774)-244-1101


COMPASSGROUPARCH.COM


Woodard

& Curran

CONSULTANT

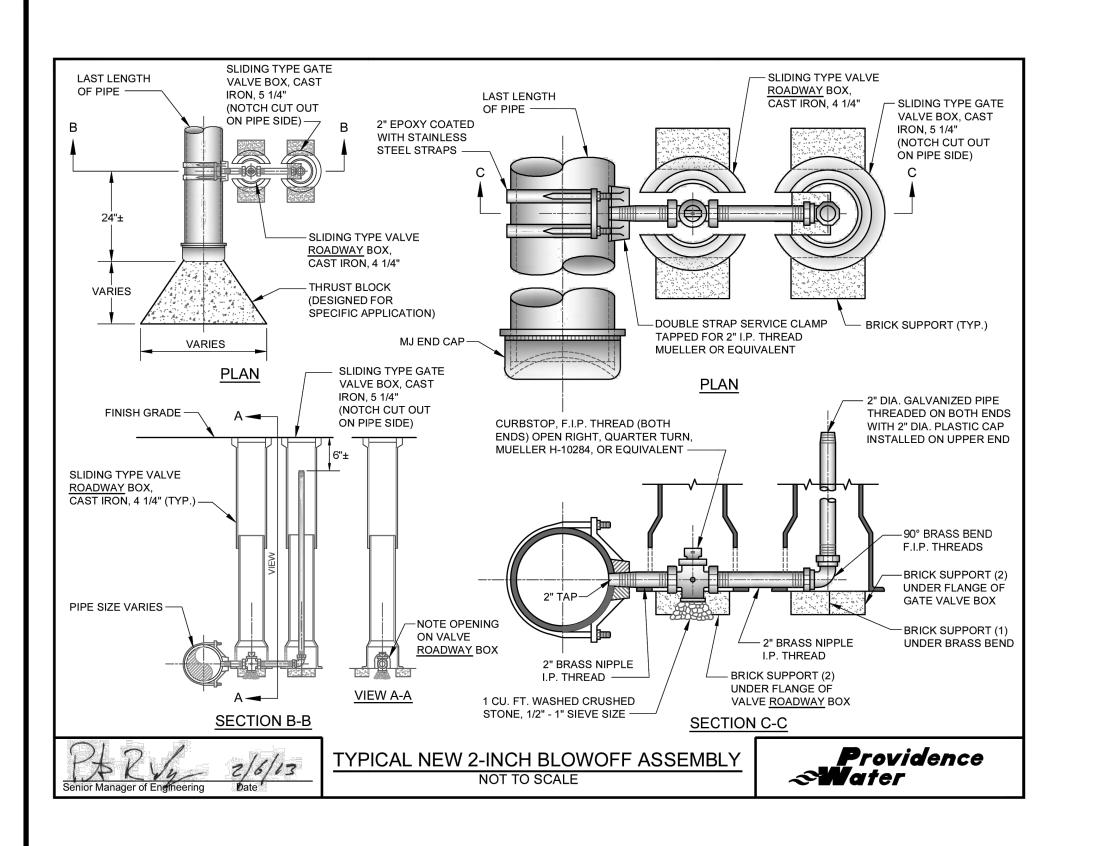

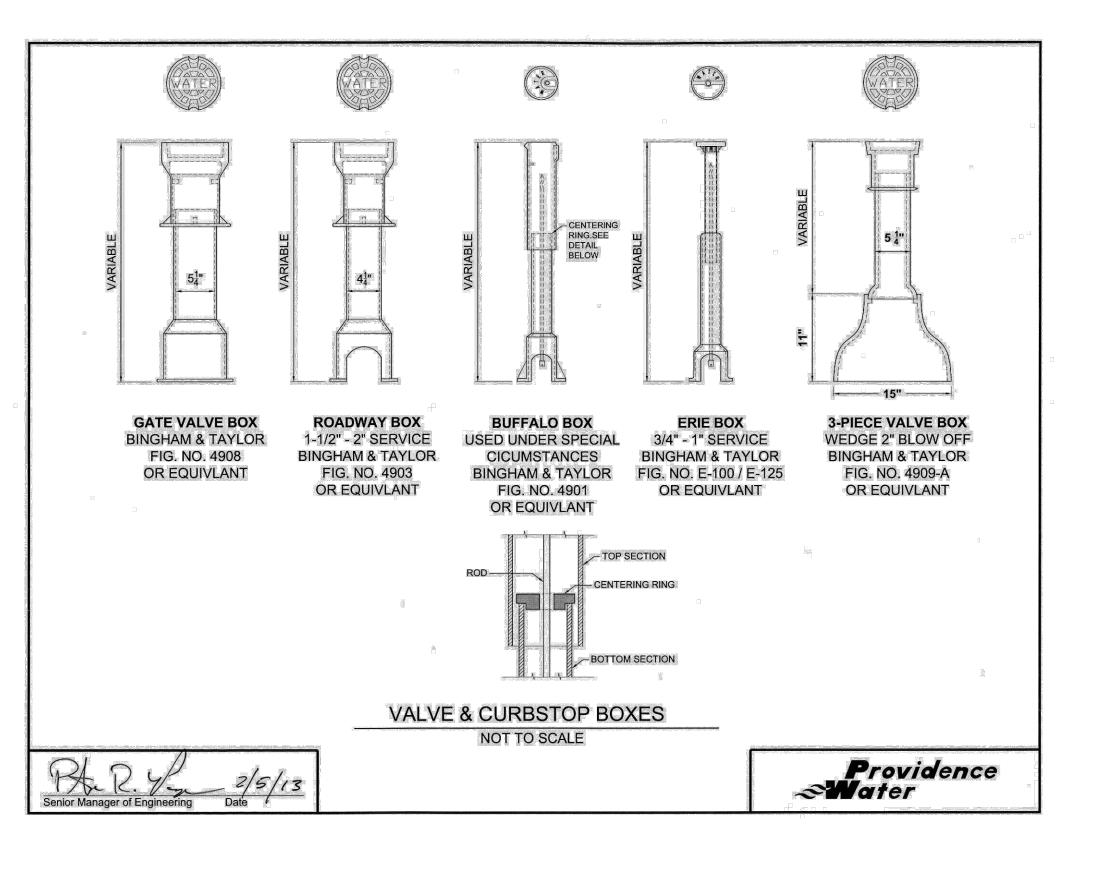

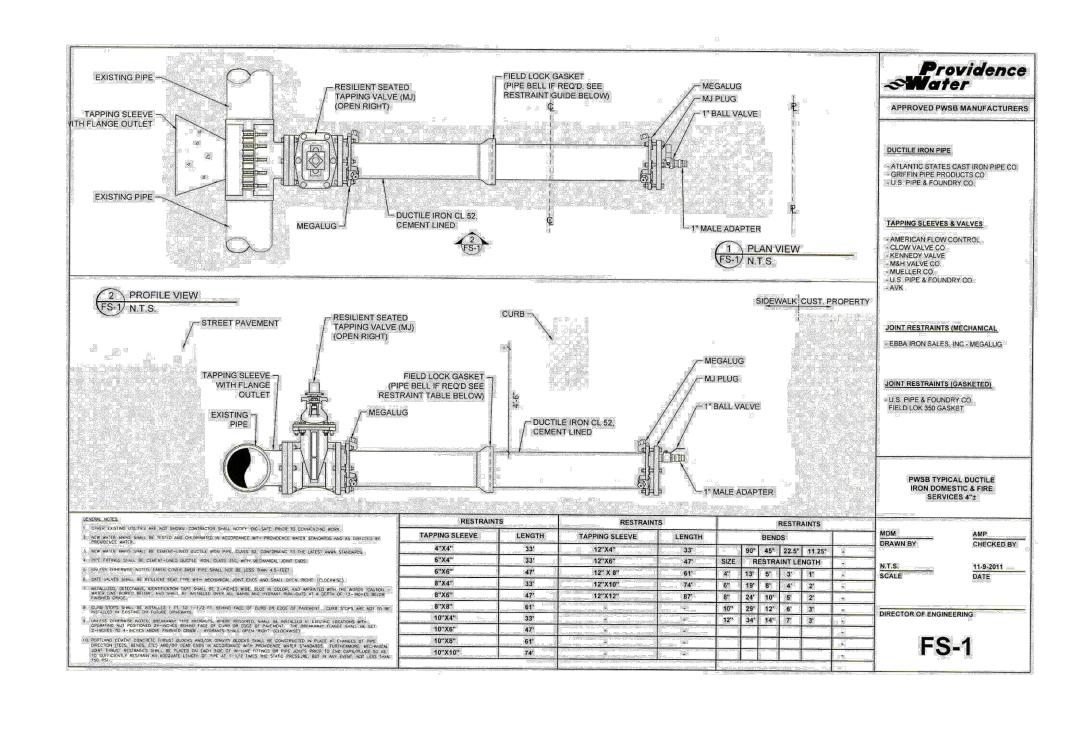



COMPASS GROUP





NOTES: ---

ISSUE DATE:

**REVISIONS:** 

6/12/2024 PERMITTING SET

DATE DESCRIPTION

FOR ALL ABBREVIATIONS, SYMBOLS LEGENDS,

AND GENERAL NOTES SEE SHEET C-000

KEY PLAN

SCALE: AS NOTED

PLAN
TRUE
NORTH
NORTH





NEW INDUSTRIAL
MANUFACTURING AND
WAREHOUSING FACILITY
FOR TACO
COMFORT SOLUTIONS, INC.
35 CARLSBAD STREET, CRANSTON, RI 02920
PROJECT NUMBER: 2022-077

DRAWN BY: KCC
REVIEWED BY: CG

CIVIL DETAILS 3

DRAWING #: C-502

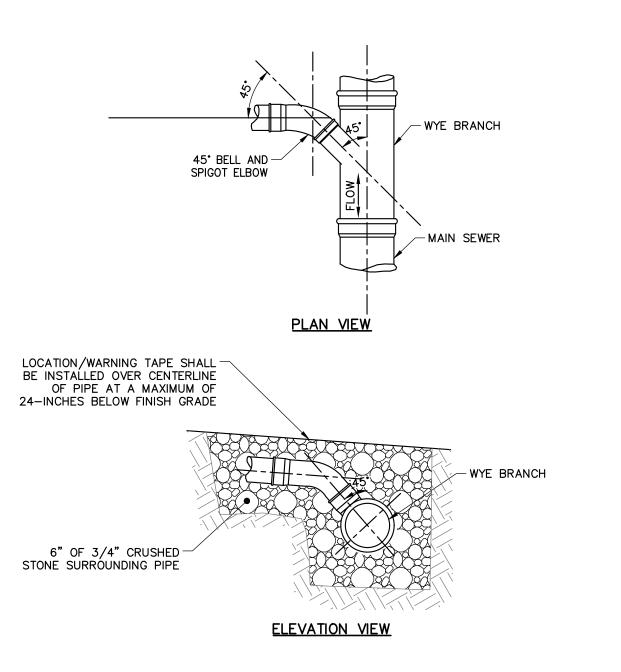

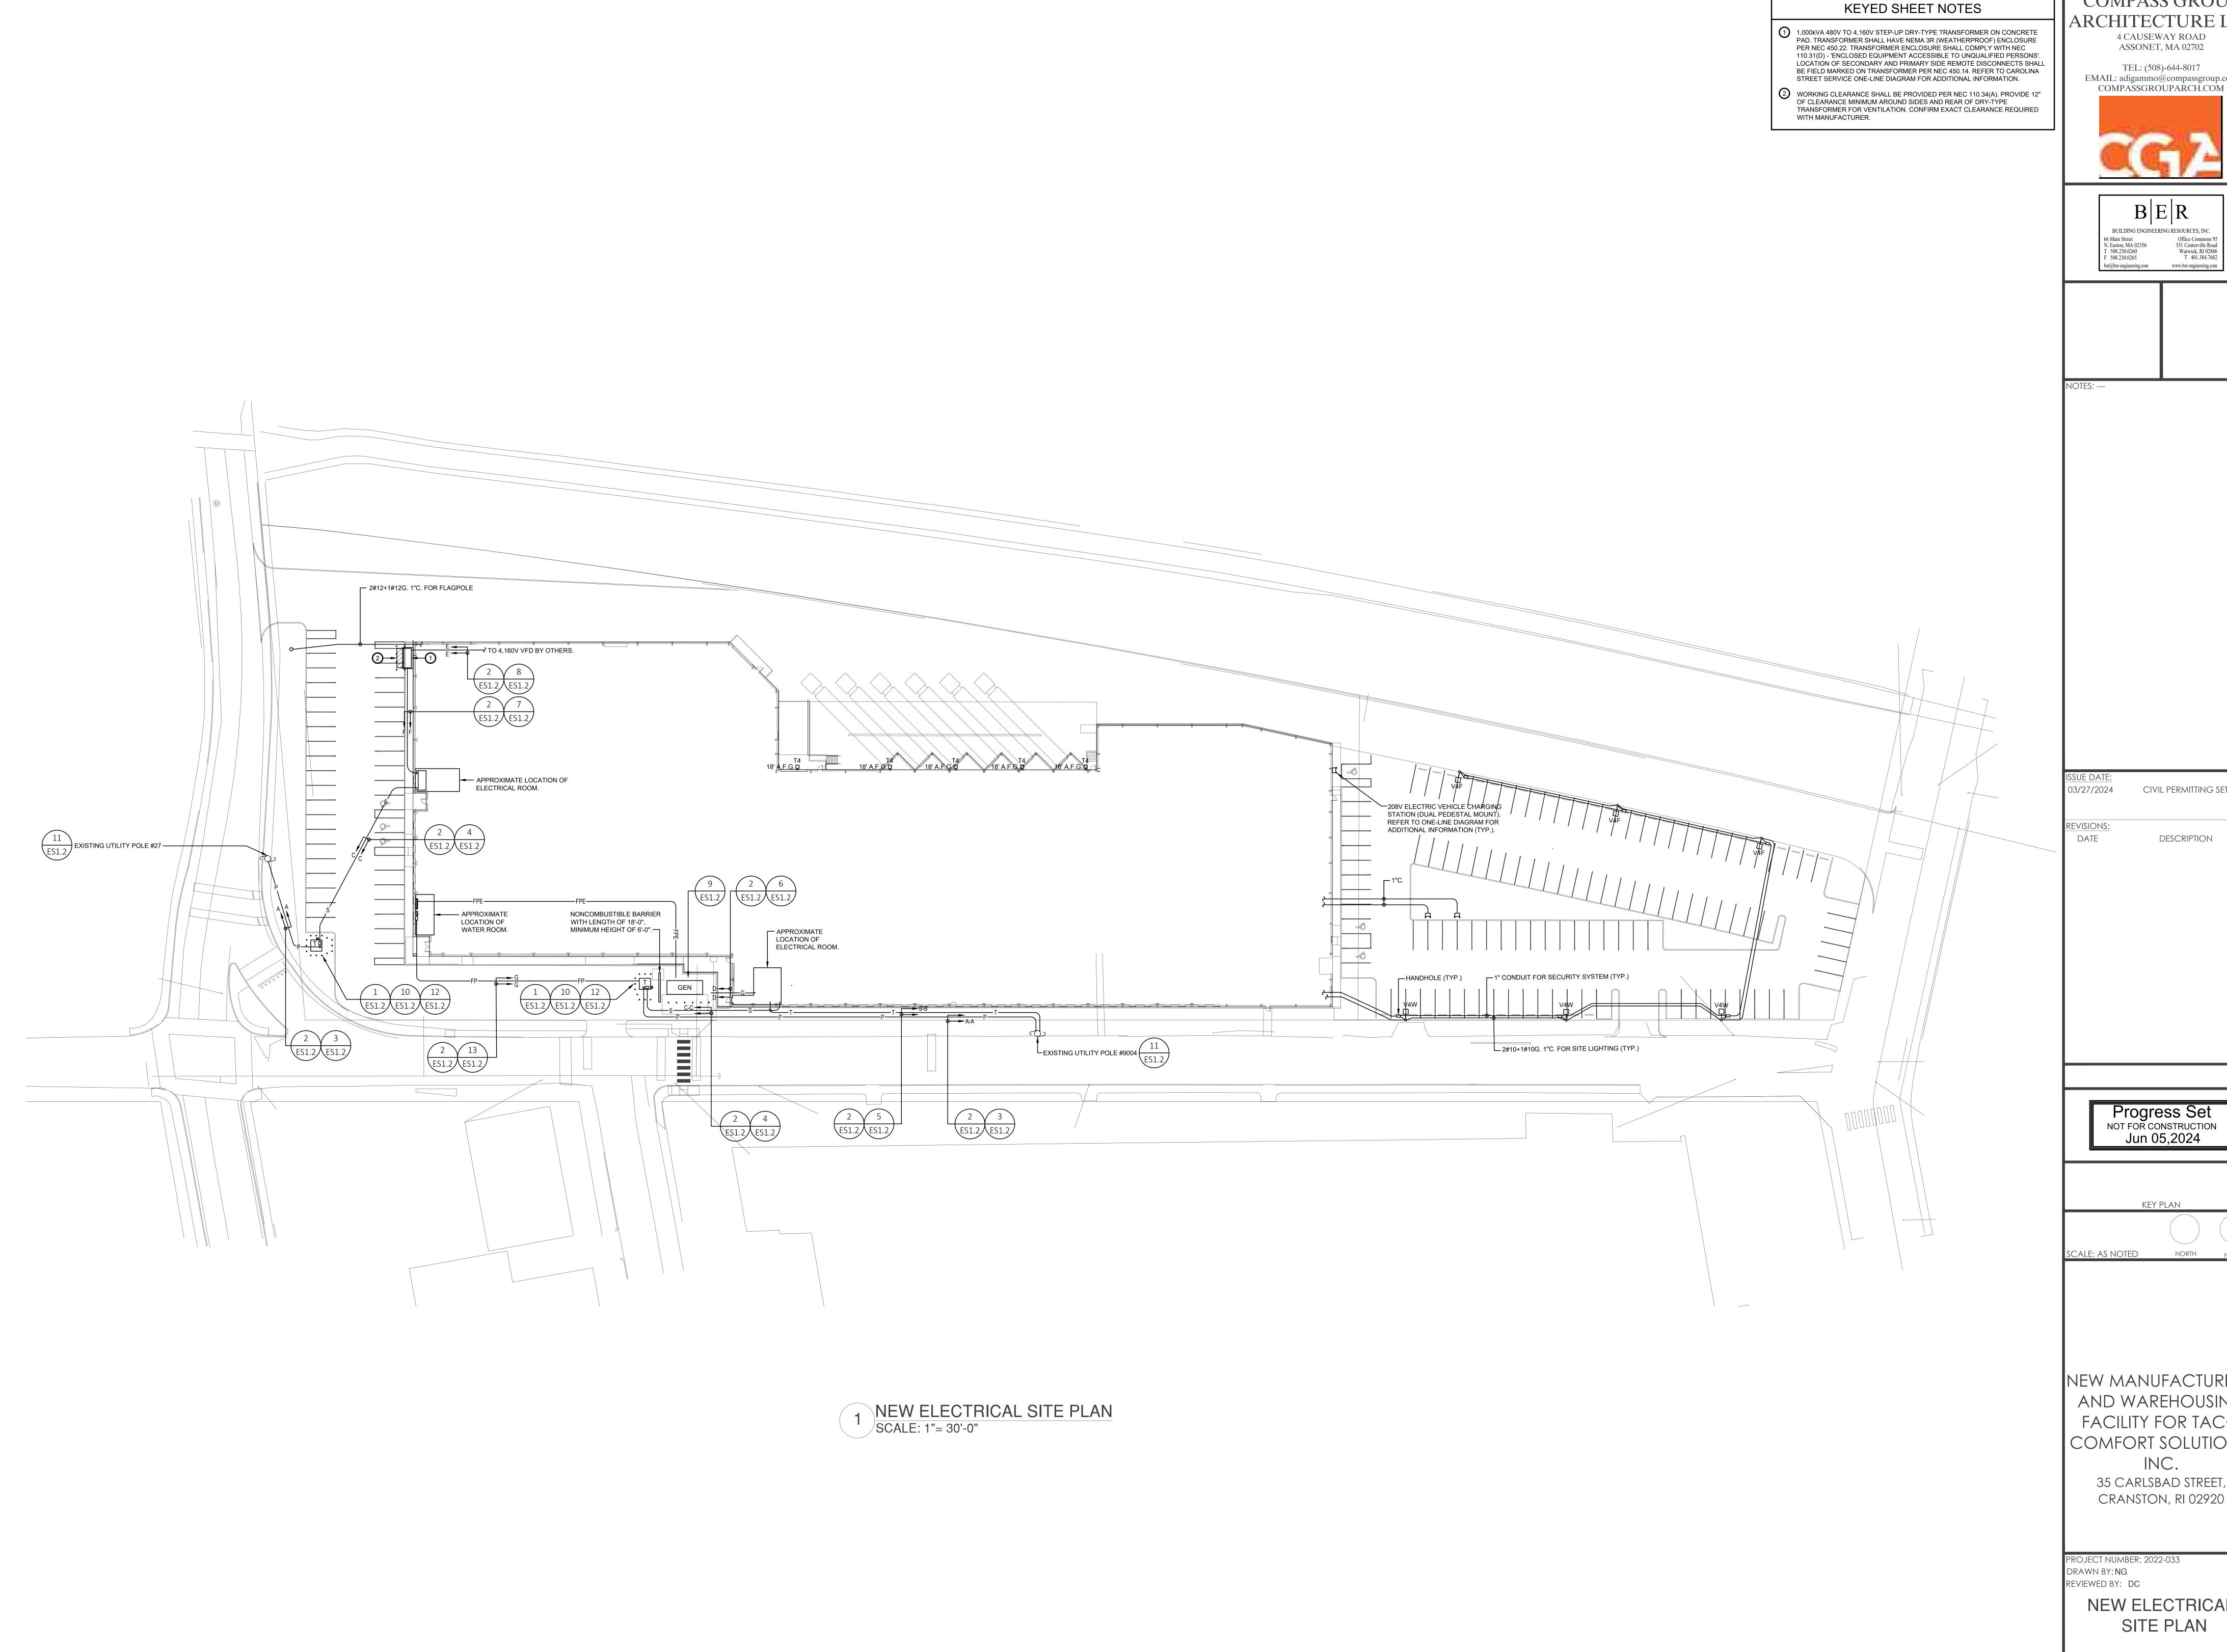

**COMPASS GROUP** 

4 CAUSEWAY ROAD ASSONET, MA 02702

TEL: (508)-644-8017 EMAIL: adigammo@compassgroup.com COMPASSGROUPARCH.COM

> BUILDING ENGINEERING RESOURCES, INC. 351 Centerville Road

CIVIL PERMITTING SET


DESCRIPTION

SCALE: AS NOTED NORTH NORTH

NEW MANUFACTURING AND WAREHOUSING FACILITY FOR TACO COMFORT SOLUTIONS,

> 35 CARLSBAD STREET, CRANSTON, RI 02920

NEW ELECTRICAL SITE PLAN

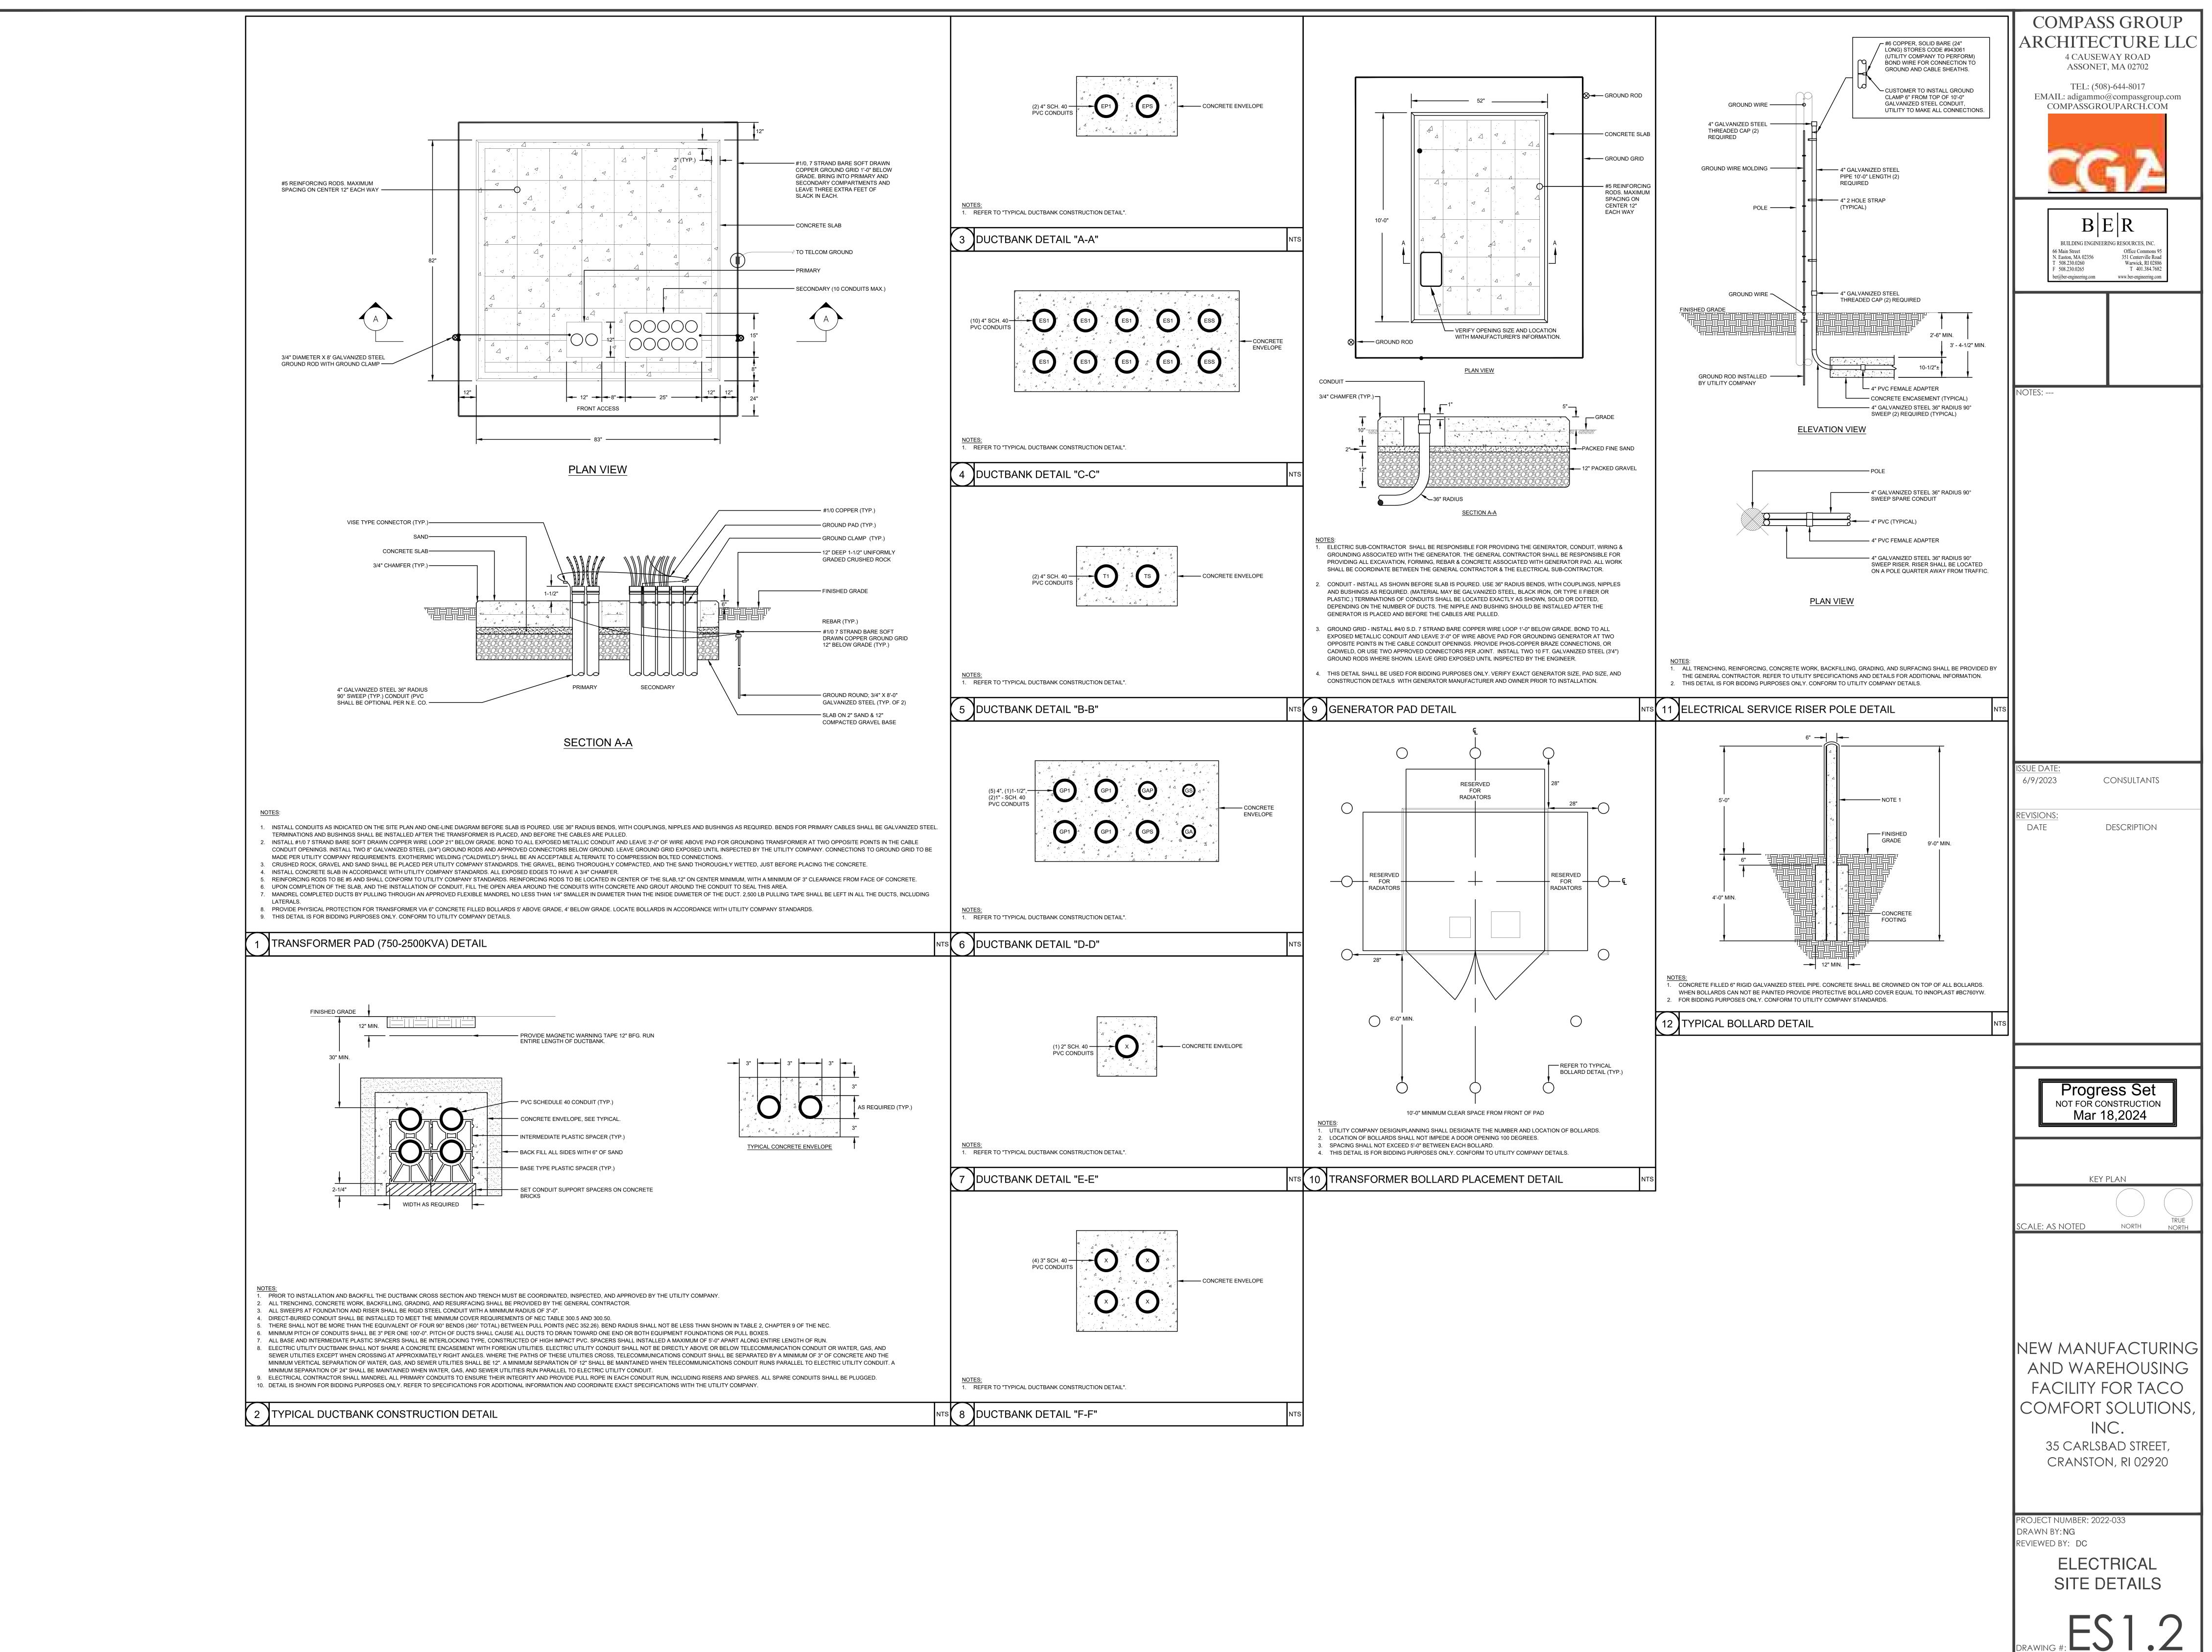

# PLANT SCHEDULE

_						
_	DECIDUOUS TREES	CODE	QTY	BOTANICAL / COMMON NAME	<u>B&amp;B</u>	CALIPER
		ARA1	24	Acer rubrum `Armstrong` / Armstrong Red Maple	B & B	2.5"Cal
•		GS2	6	Gleditsia triacanthos `Skyline` / Skyline Honey Locust	B & B;	2.5"Cal
		LT2	3	Liriodendron tulipifera / Tulip Tree	В&В	2.5"Cal
<u>F</u>	FLOWERING TREES	CODE	QTY	BOTANICAL / COMMON NAME	<u>B&amp;B</u>	CALIPER
	£ • 33	PC12	9	Prunus sargentii `Columnaris` / Columnar Sargent Cherry	B & B	2.5"Cal
•		SI3	2	Syringa reticulata `Ivory Silk` / Ivory Silk Japanese Tree Lilac Single Trunk	В&В	2.5"Cal
9	SHRUBS	CODE	QTY	BOTANICAL / COMMON NAME	CONT/B&B	SIZE
		IH2	59	llex crenata `Hoogendoorn` / Hoogendoorn Japanese Holly	3 gal	
		LR2	35	Leucothoe fontanesiana `Rainbow` / Rainbow Leucothoe	3 gal	

NOTE: LOAM AND SEED ALL DISTURBED AREAS.

### LANDSCAPE NOTES:

EIGHT WEEK PERIOD.

1. GUARANTEE THAT, UPON COMPLETION AND FINAL ACCEPTANCE, LANDSCAPE PLANTINGS CONFORM TO REQUIREMENTS OF CONTRACT DOCUMENTS. PROVIDE A WARRANTY FOR TREE PLANTINGS FOR A MINIMUM OF TWO (2) YEARS, INCLUDING TWO (2) CONTINUOUS GROWING SEASONS. COMMENCE WARRANTY ON DATE IDENTIFIED IN THE 'CERTIFICATE OF FINAL COMPLETION'.

2. REPLACEMENTS: PLANTS OF SAME SIZE AND SPECIES AS SPECIFIED, PLANTED IN THE NEXT GROWING SEASON, WITH NEW WARRANTY AND EXTENDED MAINTENANCE SERVICE COMMENCING ON THE DATE OF REPLACEMENT.

3. PLANT MATERIALS SHALL BE OF SIZE AND CALIPER REQUIRED AND CONFORM TO THE REQUIREMENTS DESCRIBED IN THE LATEST EDITION OF AMERICAN STANDARD FOR NURSERY STOCK, PUBLISHED BY THE AMERICAN ASSOCIATION OF NURSERYMEN.

4. PLANTS OF OTHER KINDS THAN THOSE NAMED IN THE PLANT SCHEDULE SHALL NOT BE ACCEPTED WITHOUT APPROVAL. REPLACEMENT PLANTS LARGER IN SIZE THAN EXISTING MAY BE USED IF APPROVED BY THE A/E, PROVIDED USE OF LARGER PLANTS DOES NOT INCREASE CONTRACT PRICE.

5. A PROFESSIONAL HORTICULTURIST/NURSERYMAN SHALL BE CONSULTED TO DETERMINE THE PROPER TIME TO MOVE AND INSTALL PLANT MATERIAL SO THAT STRESS TO THE PLANT IS MINIMIZED. PLANTING OF DECIDUOUS MATERIAL MAY BE CONTINUED DURING WINTER MONTHS PROVIDED THERE IS NO FROST IN THE GROUND AND FROST-FREE TOPSOIL PLANTING MIXTURES ARE USED.

6. UNLESS OTHERWISE APPROVED BY THE A/E, ALL PLANTS SHALL BE NURSERY GROWN IN ACCORDANCE WITH GOOD HORTICULTURAL PRACTICES AND SHALL HAVE BEEN GROWN UNDER CLIMATIC CONDITIONS SIMILAR TO THOSE IN THE LOCALITY OF THE PROJECT FOR AT LEAST

7. SET PLANTS PLUMB AND AT SUCH A LEVEL THAT AFTER SETTLEMENT THEY BEAR THE SAME RELATION TO THE SURROUNDING GROUND AS THEY BORE TO THE GROUND FROM WHICH THEY WERE DUG. SETTLE BACKFILL MATERIAL FOR PLANTS, THOROUGHLY & PROPERLY, BY FIRMING OR TAMPING. ACCOMPANY BACKFILLING WITH THOROUGH WATERING UNLESS OTHERWISE

APPROVED. FORM SAUCER CAPABLE OF HOLDING WATER AROUND INDIVIDUAL PLANTS.

8. FERTILIZE SHRUB BEDS WITH 10-6-4 FERTILIZER AT THE RATE OF 3 POUNDS PER 100 SQUARE FEET OF SURFACE AREA, BROAD CAST. APPLY THE FERTILIZER UNIFORMLY TO THE SURFACE BEDS AND WORK INTO THE UPPER TWO (2) INCHES OF SOIL. FERTILIZE INDIVIDUAL TREES AT THE RATE OF ONE (1) AGRIFORM PELLET PER INCH OF TREE DIAMETER (FOLLOW MANUFACTURER'S WRITTEN INSTRUCTIONS). APPLY A SECOND APPLICATION OF FERTILIZER TO ALL PLANT ITEMS AT THE SAME SPECIFIED RATES OVER THE MULCH AT THE END OF AN

9. CONTAINER GROWN MATERIALS: REMOVE PLANT FROM CONTAINER AND "BUTTERFLY" ROOT BALL OR OTHERWISE SPREAD OUT ROOTS ON SETTING MOUND. BACKFILL SHALL BE SIFTED THROUGH THEM AND SOLIDLY FIRMED.

10. AFTER PLANTING PRUNE ONLY BROKEN OR DEFORMED BRANCHES AND IN SUCH MANNER AS TO PRESERVE NATURAL CHARACTER OF PLANT.

11. IMMEDIATELY AFTER PLANTING, STAKE TREES OVER FIVE (5) FEET AS INDICATED ON DETAIL DRAWING INDICATED OR APPROVED BY THE OWNERS REPRESENTATIVE. MULCH SHALL BE APPLIED A MINIMUM OF THREE (3) INCHES IN DEPTH IN ALL PLANTING BEDS, AS INDICATED ON THE DRAWINGS.

12. THE PLANTS SHALL BE WATERED IMMEDIATELY FOLLOWING PLANTING, PREFERABLY WHEN TWO THIRDS OF THE BACKFILL HAS BEEN PLACED SO ALL AIR POCKETS ARE REMOVED AND THE PLANT PROPERLY SET. ADDITIONAL WATERING SHALL BE MADE AT LEAST ONCE EVERY THREE (3) WEEKS UNLESS OTHERWISE DIRECTED UNTIL FINAL ACCEPTANCE OF THE PLANT MATERIAL.

13. INSTALL 'JUTE MESH' EROSION CONTROL FABRIC WHERE FINAL GRADES ARE 3:1 (33%) OR GREATER PER MANUFACTURER'S INSTRUCTIONS.

14. UNLESS OTHERWISE SPECIFIED, CONTRACTOR TO LOAM AND SEED ALL DISTURBED AREAS. SEEDING NOTE: USE UNIVERSITY OF RHODE ISLAND NO. 2 IMPROVED SEED MIX OR EQUAL. TREE PRUNING NOTE: STREET TREES SHOULD BE PRUNED TO MAINTAIN A MINIMAL BRANCH HEIGHT OF 8' WITHIN TWO (2) YEARS OF INSTALLATION OF THE TREE.


15. LANDSCAPE ESTABLISHMENT AND MAINTENANCE NOTE: CONTRACTOR SHALL ENSURE THAT ALL LAWN AREAS AND PLANTINGS ARE FULLY ESTABLISHED AND ACCEPTABLE TO THE OWNER'S REPRESENTATIVE PRIOR TO RELINQUISHING THEIR RESPONSIBILITIES FOR MAINTENANCE OF THESE AREAS.


16. TREE PROTECTION NOTE: NO MATERIAL, TEMPORARY SOIL DEPOSIT OR EXCAVATION SHALL OCCUR WITHIN FOUR FEET OF SHRUBS OR WITHIN TWO FEET OF THE DRIP LINE OF ANY SHRUBS OR TREES TO REMAIN. ANY RETAINED EXISTING VEGETATION SHALL BE PROTECTED AS PER DETAIL ON PLAN.

## CITY OF CRANSTON LANDSCAPING STANDARDS TITLE 17-ZONING. Supplementary Regulations, 17.83.140 Development and and Landscaping Design Standards

ZONING CRITERIA	REQUIRED	PROPOSED	REFE
Corner lot visibility	Nothing shall be erected to impede vision between a height of 2 ½ feet and 10 feet of a corner lot 30 feet from property boundary lines	Nothing erected to impede vision between a height of 2 ½ feet and 10 feet of a corner lot 30 feet from property boundary lines	17.20 /
Driveway visibility	Nothing shall be erected to impede vision between a height of 3 ½ feet and 10 feet extending from either side of a driveway	Nothing erected to impede vision between a height of 3 ½ feet and 10 feet extending from either side of a driveway	17.20 E
15% of a development's parcel to be landscaped	15% minimum or 32,978 sq. ft. (219,854 total lot sq. ft. x 15%)	Landscape on property ONLY: 7.6% (16,668 sq. ft. landscape/219,854 sq. ft. lot)  Landscape on property (16,668sf) and R.O.W. (10,316sf) COMBINED: 12.2% (26,984 sq. ft. landscape/219,854sf)	17.£ C.(
Street trees along frontage	1 tree for every 35 linear feet of frontage or 36 trees (1,249 lin. ft./35 lin. ft.)	24 trees (due to utility pole conflicts and planting bed widths)	17.8 C.(
Deciduous tree minimum caliper	2 ½ inch caliper	2 ½" caliper	17.8 C.(
Buffer area dimensions	Minimum 8 feet in height. Minimum 10 foot wide landscape strip along property lines parallel to a street where parking or circulations areas abut a street	No buffer along parking at street frontage. 0 to 12 feet wide.	17.8 C.(6
Buffer area dimensions	Minimum 8 feet in height. Minimum 5 foot wide landscape strip along side and rear property lines where parking and circulation areas are adjacent to abutting properties.	0 to 2' buffer along rear circulation areas.	17.8 C.(6
Buffer area dimensions	Minimum 8 feet in height. Where a more intensive use abuts a less intensive use, a 25 foot wide buffer strip may be required.	N/A	17.8 C.(6)


ZONING CRITERIA	REQUIRED	PROPOSED	REFERENCE
Landscape area required within a parking area	Minimum 10 square feet for each parking space or 1,140 sq. ft. req'd. (114 spaces x 10 sq. ft.) (Area B)	0 sq. ft. PARKING AREA 'A' 5,398 sq. ft. PARKING AREA 'B'	17.84.140 C.(7)(a)
Parking area to be shaded by deciduous trees	Minimum of 20% parking shading (using 706 sq. ft. or 30 foot diameter crown) surrounded by 100 sq. ft. of unpaved area' PARKING AREA 'A' or 2,350 sq. ft. or 4 trees (12,080 sq. ft. parking lot x 20%) PARKING AREA 'B' or 7,950 sq. ft. or 12 trees (39,747 sq. ft. parking lot x 20%)	6* trees PARKING AREA 'A' 22* trees PARKING AREA 'B'  *includes street trees adjacent to parking	17.84.140 C.(7)(b)
Terminal island requirement	Each row of parking spaces shall be terminated by a landscape island not less than 6 feet wide and 12 feet long or 18 islands project—wide.	10 terminal islands provided	17.84.140 C.(7)(c)
Continuous island requirement	1 continuous landscape island shall be provided between every 4 rows of parking spaces.	N/A	17.84.140 C.(7)(c)

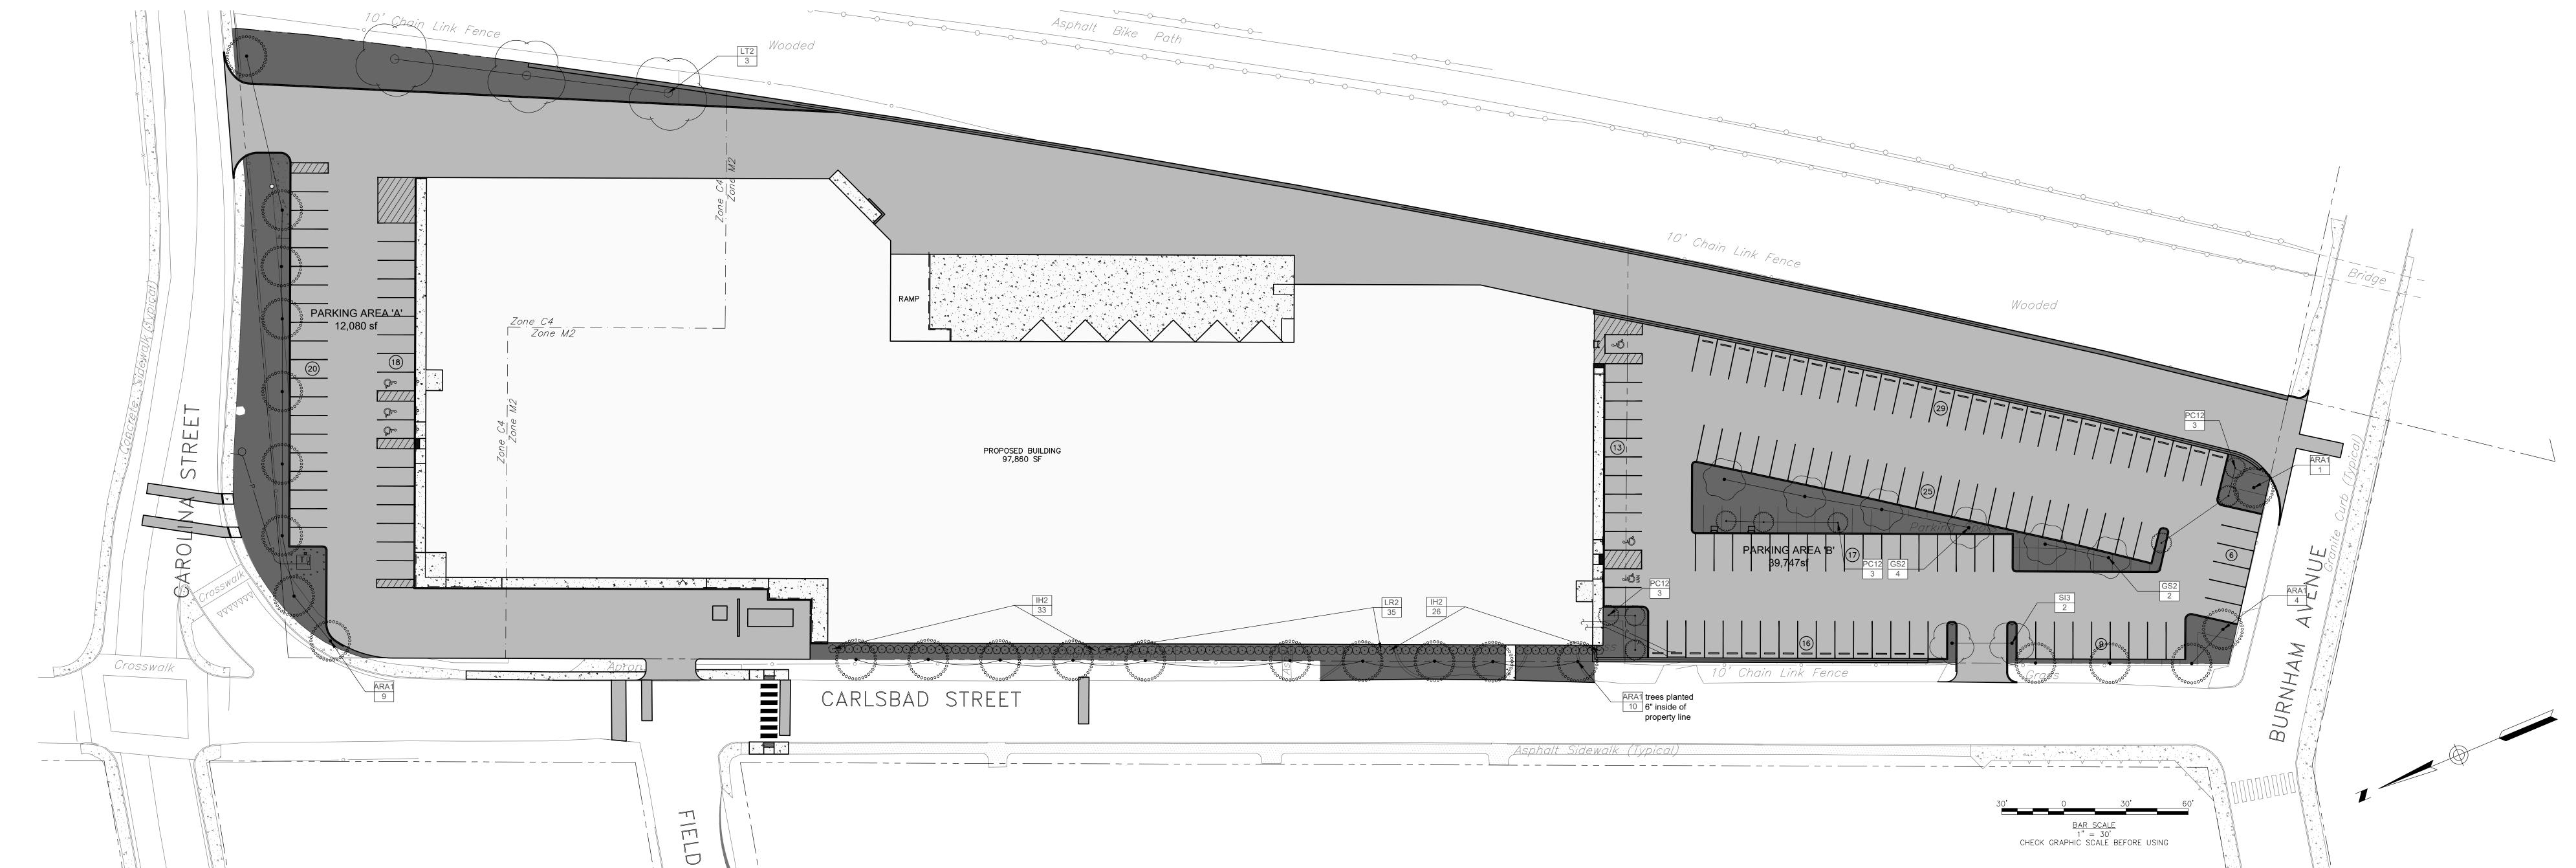

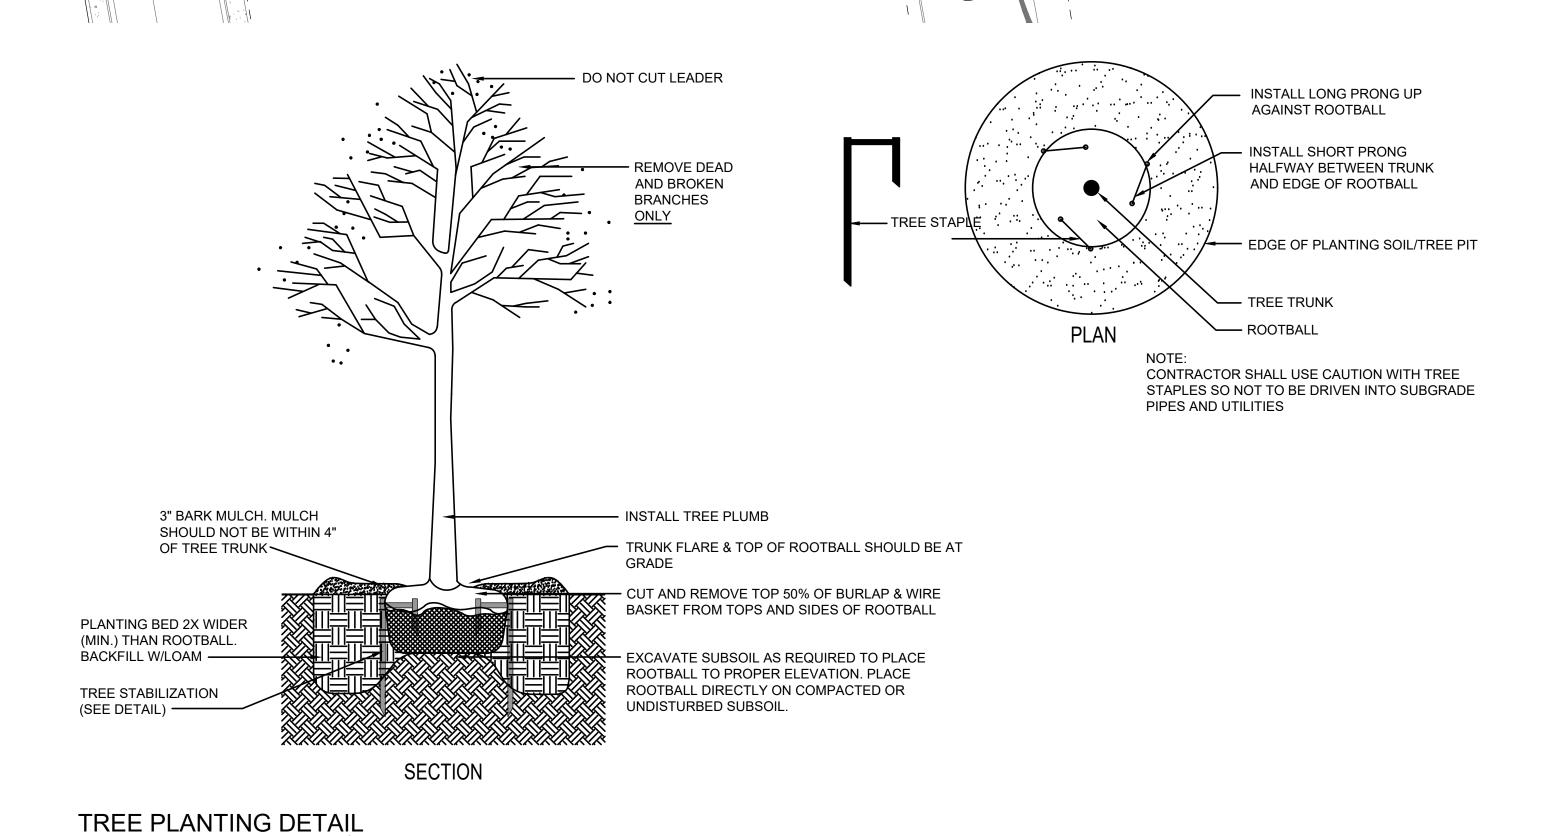

SHRUB PER PLAN - 3" PINEBARK MULCH (UNLESS PLANT SHRUB AT DEPTH OTHERWISE NOTED ON PLANS) EQUAL TO 2" LESS THAN THE DISTANCE FROM BOTTOM OF ROOTBALL EXCAVATED SOIL TO ROOT COLLAR — 6" LOAM — **BACKFILL** BURLAP FROM TOP WITH LOAM-1/3 OF ROOTBALL **ROOTBALL ON** UNDISTURBED —GEOTEXTILE FABRIC DIAMETER (MIN.) SUBGRADE — NOTE: REFER TO RIDOT STANDARD SPECIFICATION SECTION L.06, PLANTING, FOR SPECIFICS

SHRUB PLANTING DETAIL

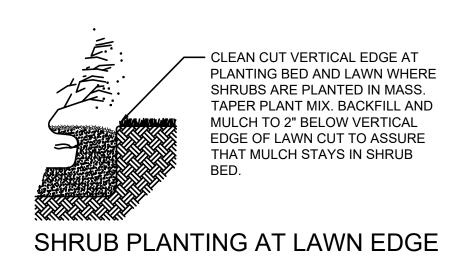

REVISIONS: DESCRIPTION

**COMPASS GROUP** 

ARCHITECTURE LLC

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ASSONET, MA 02702

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COMPASSGROUPARCH.COM

Woodard

& Curran

CONSULTANT

**KEY PLAN** SCALE: AS NOTED

FOR ALL ABBREVIATIONS, SYMBOLS LEGENDS, AND GENERAL NOTES SEE SHEET C-000

**NEW INDUSTRIAL** MANUFACTURING AND WAREHOUSING FACILITY FOR TACO COMFORT SOLUTIONS, INC. 35 CARLSBAD STREET, CRANSTON, RI 02920

PROJECT NUMBER: 2022-077 DRAWN BY: KCC REVIEWED BY: CG LANDSCAPE PLAN

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